PROJECT:

PROPOSED NEW 1 UNIT STANDARD DESIGN OF FARM LABOUR QUARTERS, BRUNEI DARUSSALAM (FOR 2 PERSONS)

CLIENT:

DEPARTMENT OF AGRICULTURE AND AGRIFOOD, **BRUNEI DARUSSALAM**

ADDRESS:

N/A

Schematic Design Project Status Project Date 18/08/2022

No	Description	Date



Contact No: 2610380

Department of Agriculture & Agrifood, BD

Project Name And Address

PROPOSED NEW 1 UNIT STANDARD DESIGN OF FARM LABOUR QUARTERS, BRUNEI DARUSSALAM (FOR 2 PERSONS)

Drawing Name

20 m

COVER PAGE & DRAWING NOTES

Designed By KHS			
Drawn By	n By KHS,SHA		
Checked By	AQI		
Scale	1:20		
Date	08/31/22		
Project No	Sheet No	Rev.	

DRAWING NOTES

- The following designs were developed up to Working Drawing (with pre-approval from ABCi for building design/TBC) and are considered as sufficient for Authority Submission.
- 2. No sites were allocated for the units at this stage. Therefore, once a site is allocated, Applicant(s) will need to appoint Qualified Person(s) to include the additional drawing information.

DOOR TAG

ROOM TAG

WINDOW TAG

GRID MARKER

- 3. These changes and/or additional information will need to be included in the relevant drawings as per required by the Authority.
- These changes and/or additional information will be subjected to the approval of Client, Department of Agriculture and Agrifood, Brunei Darussalam.

ROOM NAME

10 m²

- All development applications for the units will require a Qualified Person(s) to be appointed for the process of applying for:
 - Planning Approval (including Infrastructure Submission –applicable for 1 unit development)
 - **Building Approval**
 - Permit to Start Construction
 - Occupational Permit

ABBREVIATIONS

RL	Roofline	AW	Aluminum Awning Wind
DP	Downpipe	LV	Aluminum Louvre Windo
FT	Floor Trap	FG	Fixed Glass
GT	Gully Trap	SHR	Shower
MH	Manhole	NTS	Not to Scale
FFL	Final Floor Level	APPROX	Approximate
CL	Ceiling Level	AVG	Average
T.B.C	To Be Confirmed	R.C	Reinforced concrete
NGL	Natural Ground Level	EXT	Existing
OHC	Overhead Cupboard	QTY	Quantity
WMS	Washing Machine Space	RM	Room
W.I.R	Walk-in-Robe	BDRM	Bedroom
SGD	Sliding Glass Door	SPEC	Specification
SW	Aluminum Sliding Window	TYP	Typical
DH	Aluminum Double Hung Window		

SYMBOLS

SECTION A


SECTION MARKER



NORTH POINT & KIBLAT

GRAPHICAL SCALE BAR

	DRAWING LIST				
No.	No. Sheet Number Sheet Name			Sheet Scale	
1	1	COVER PAGE & DRAWING NOTES	08/31/22	1 : 20	
2	A1	DRAWING LIST & SITE DEVELOPMENT PLAN	08/16/22	1:200	
4	B1	GROUND FLOOR & ROOF PLAN	08/16/22	1:100	
5	C1	GROUND FLOOR CEILING PLAN	08/16/22	1:100	
6	D1	ELEVATIONS	08/16/22	1:100	
7	E1	SECTION A-A & SECTION B-B	08/16/22	1:100	
8	F1	WINDOW SCHEDULE	08/25/22	1:50	
9	F2	DOOR & IRONMONGERY SCHEDULE	09/02/22	1:50	
10	F3	VENTILATION, MATERIAL, SANITARY & FITTING SCHEDULES	08/25/22	As indicated	
11	G1	TB & SHOE WASHING AREA DETAILS	08/25/22	As indicated	
12	G2	KITCHEN DETAILS	08/30/22	1:50	
13	G3	DOOR JAMB, TYPICAL DPC, GUTTER AND SURFACE DRAIN DETAILS	08/26/22	As indicated	
14	K	ELECTRICAL LAYOUT	09/02/22	1:100	
15	P1	ROOM PLAN & FURNITURE SCHEDULE	08/31/22	As indicated	

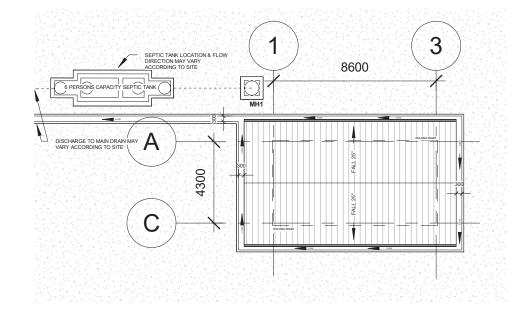

DRAWING LIST & SITE DEVELOPMENT PLAN

Designed By	KHS	
Drawn By	KHS,SHA	
Checked By	AQI	
Scale	1:200	
Date	08/16/22	
Project No	Sheet No	Rev.
PR120	A1	

SCALE 1:200

1:200 @ A3			
0	4	10	20 m

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Paper size:	A3-LV	
Project Status	Schematic Design	
Project Date	18/08/2022	
Notes		

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No	Description	Date



Contact No: 2610380



Client Name and Approved by:


Department of Agriculture & Agrifood, BD

Project Name And Address

PROPOSED NEW 1 UNIT STANDARD DESIGN OF FARM LABOUR QUARTERS, BRUNEI DARUSSALAM (FOR 2 PERSONS)

Drawing Name

	DRAWING LIST				
No.	No. Sheet Number Sheet Name			Sheet Scale	
1	1	COVER PAGE & DRAWING NOTES	08/31/22	1 : 20	
2	A1	DRAWING LIST & SITE DEVELOPMENT PLAN	08/16/22	1:200	
4	B1	GROUND FLOOR & ROOF PLAN	08/16/22	1:100	
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DRAWING LIST & SITE DEVELOPMENT PLAN

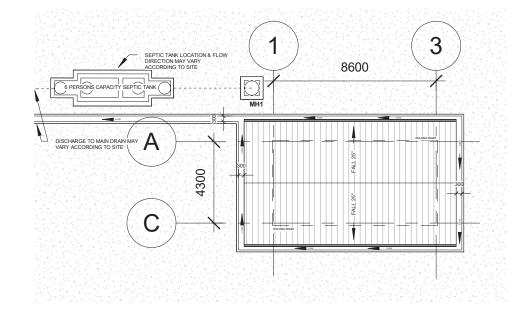Designed By	KHS	
Drawn By	KHS,SHA	
Checked By	AQI	
Scale	1:200	
Date	08/16/22	
Project No	Sheet No	Rev.
PR120	A1	

SCALE 1:200

1:200 @ A3			
0	4	10	20 m

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Paper size:	A3-LV	
Project Status	Schematic Design	
Project Date	18/08/2022	
Notes		

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No	Description	Date



Contact No: 2610380




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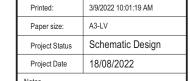
Department of Agriculture & Agrifood, BD

Project Name And Address

PROPOSED NEW 1 UNIT STANDARD DESIGN OF FARM LABOUR QUARTERS, BRUNEI DARUSSALAM (FOR 2 PERSONS)

Drawing Name



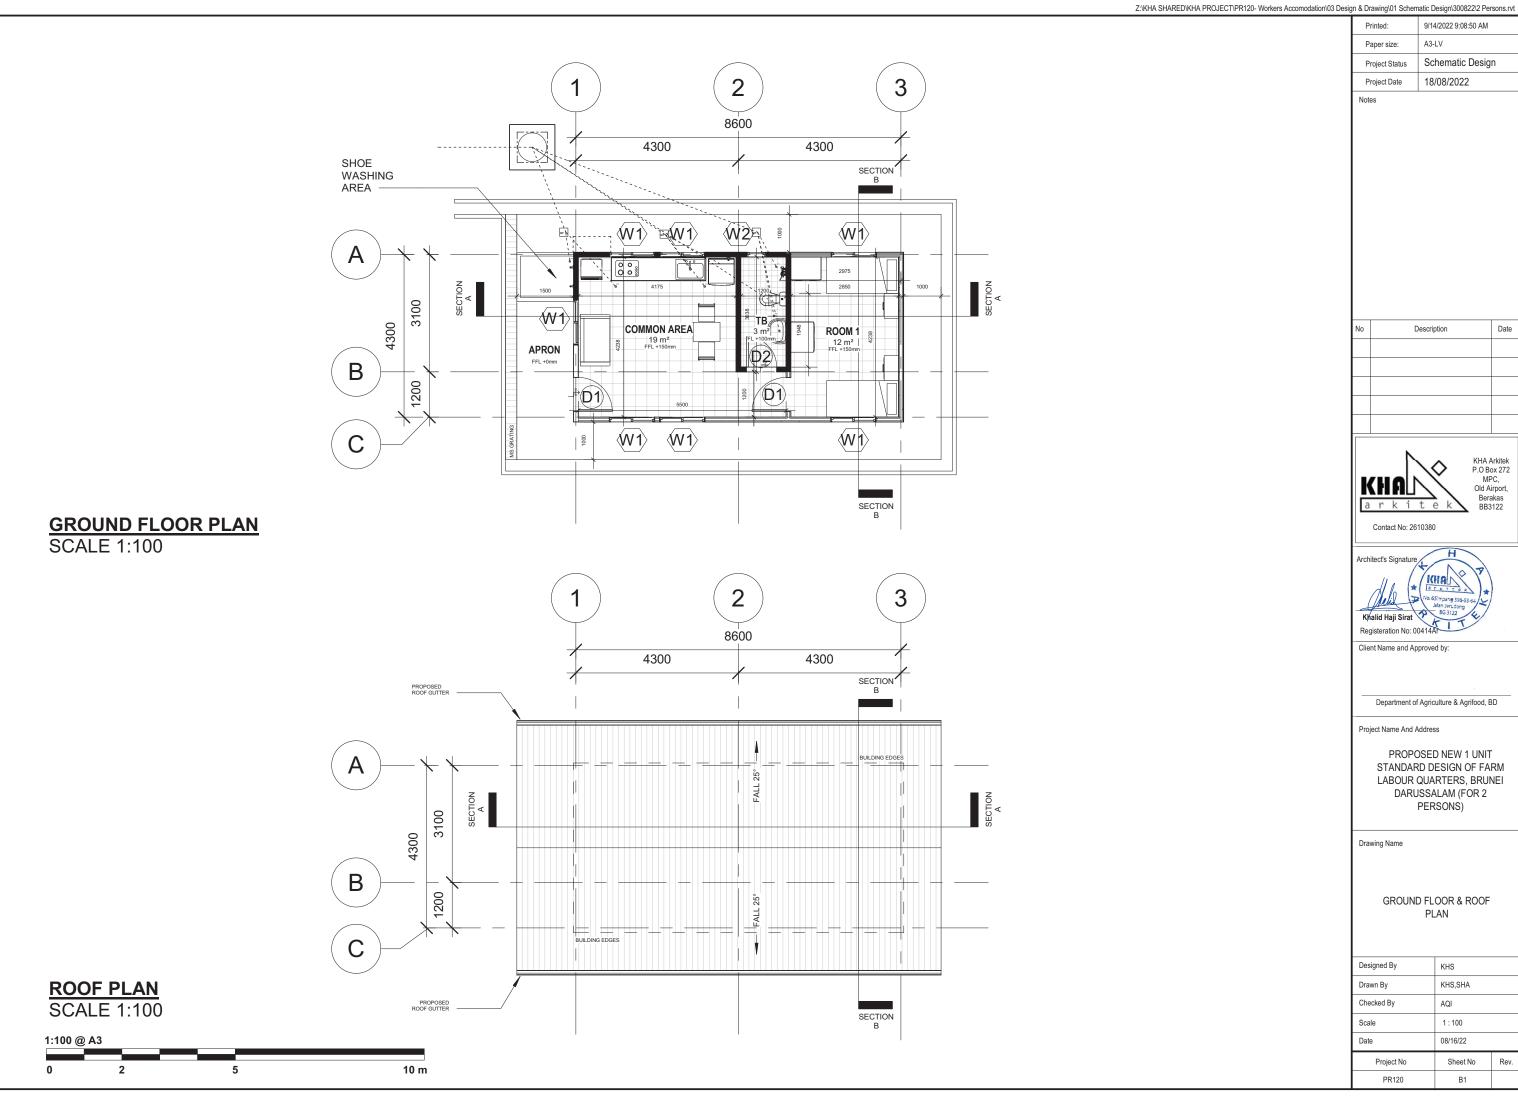

Notes

No	Description	Date



Contact No: 2610380

Registeration No: 00414Ar

Client Name and Approved by:

Department of Agriculture & Agrifood, BD


Project Name And Address

PROPOSED NEW 1 UNIT STANDARD DESIGN OF FARM LABOUR QUARTERS, BRUNEI DARUSSALAM (FOR 2 PERSONS)

Drawing Name


GROUND FLOOR CEILING PLAN

Designed By	KHS	
Drawn By	KHS,SHA	
Checked By	AQI	
Scale	1:100	
Date	08/16/22	
Project No	Sheet No	Rev.
PR120	C1	

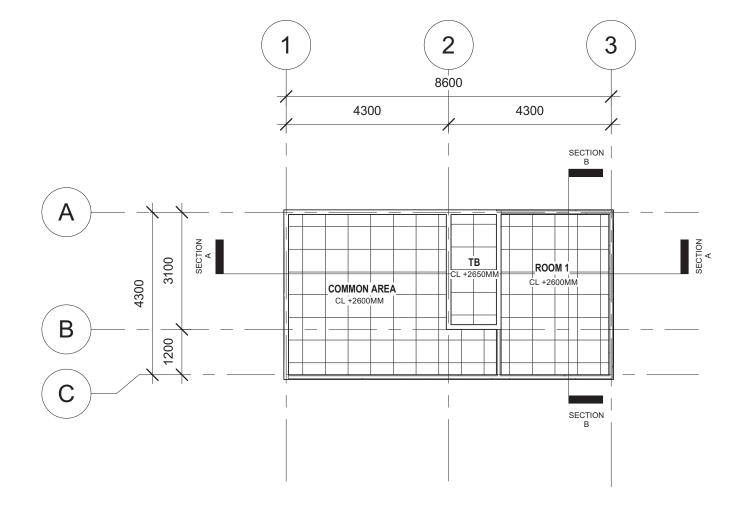


GROUND FLOOR CEILING PLAN SCALE 1:100

1:100 @	A3		
0	2	5	10 m

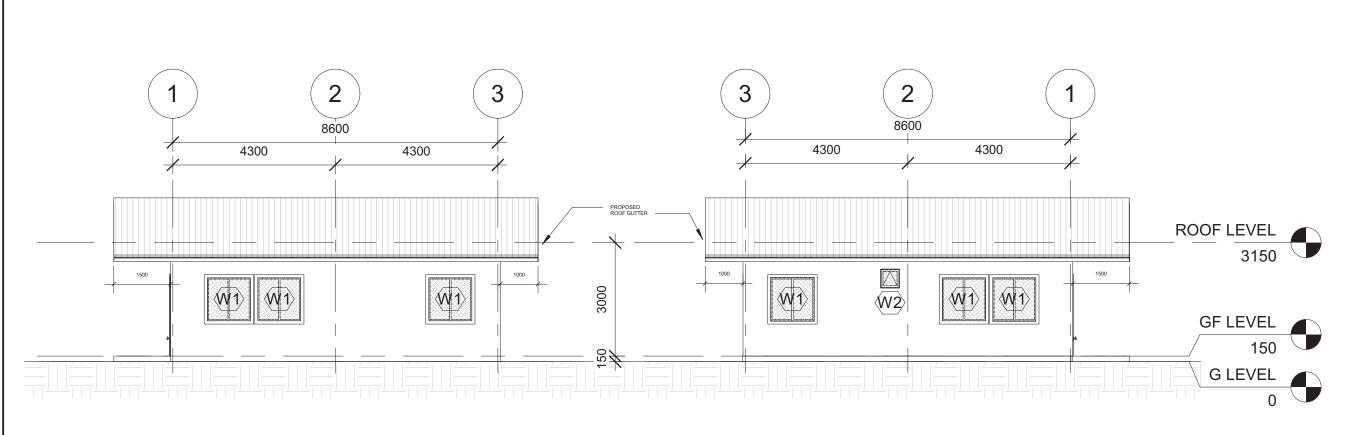

FRONT & REAR ELEVATION SCALE 1:100

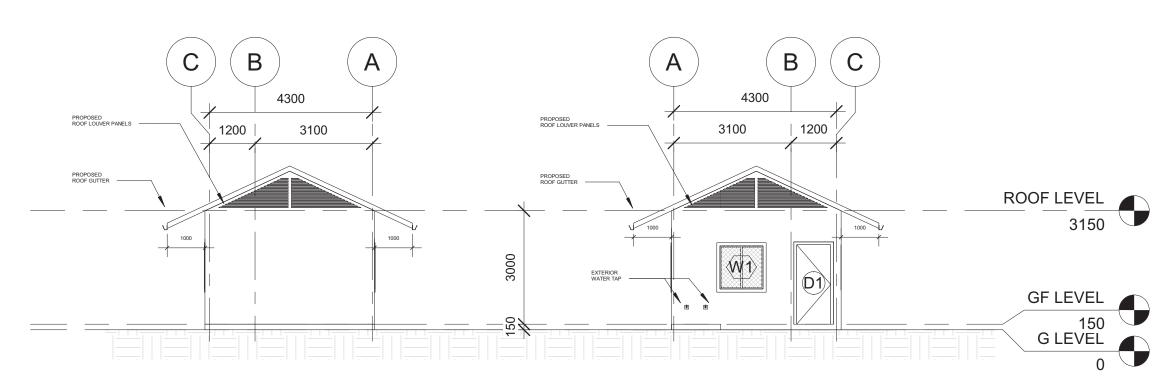

RIGHT & LEFT ELEVATION

SCALE 1:100

1:100 @) A3		
0	2	5	10 m

Printed:	3/9/2022 10:01:20 AM
Paper size:	A3-LV
Project Status	Schematic Design
Project Date	18/08/2022

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Client Name and Approved by:

Department of Agriculture & Agrifood, BD


Project Name And Address

PROPOSED NEW 1 UNIT STANDARD DESIGN OF FARM LABOUR QUARTERS, BRUNEI DARUSSALAM (FOR 2 PERSONS)

Drawing Name

ELEVATIONS

Designed By	KHS	
Drawn By	KHS,SHA	
Checked By	AQI	
Scale	1:100	
Date	08/16/22	
Project No	Sheet No	Rev.
PR120	D1	

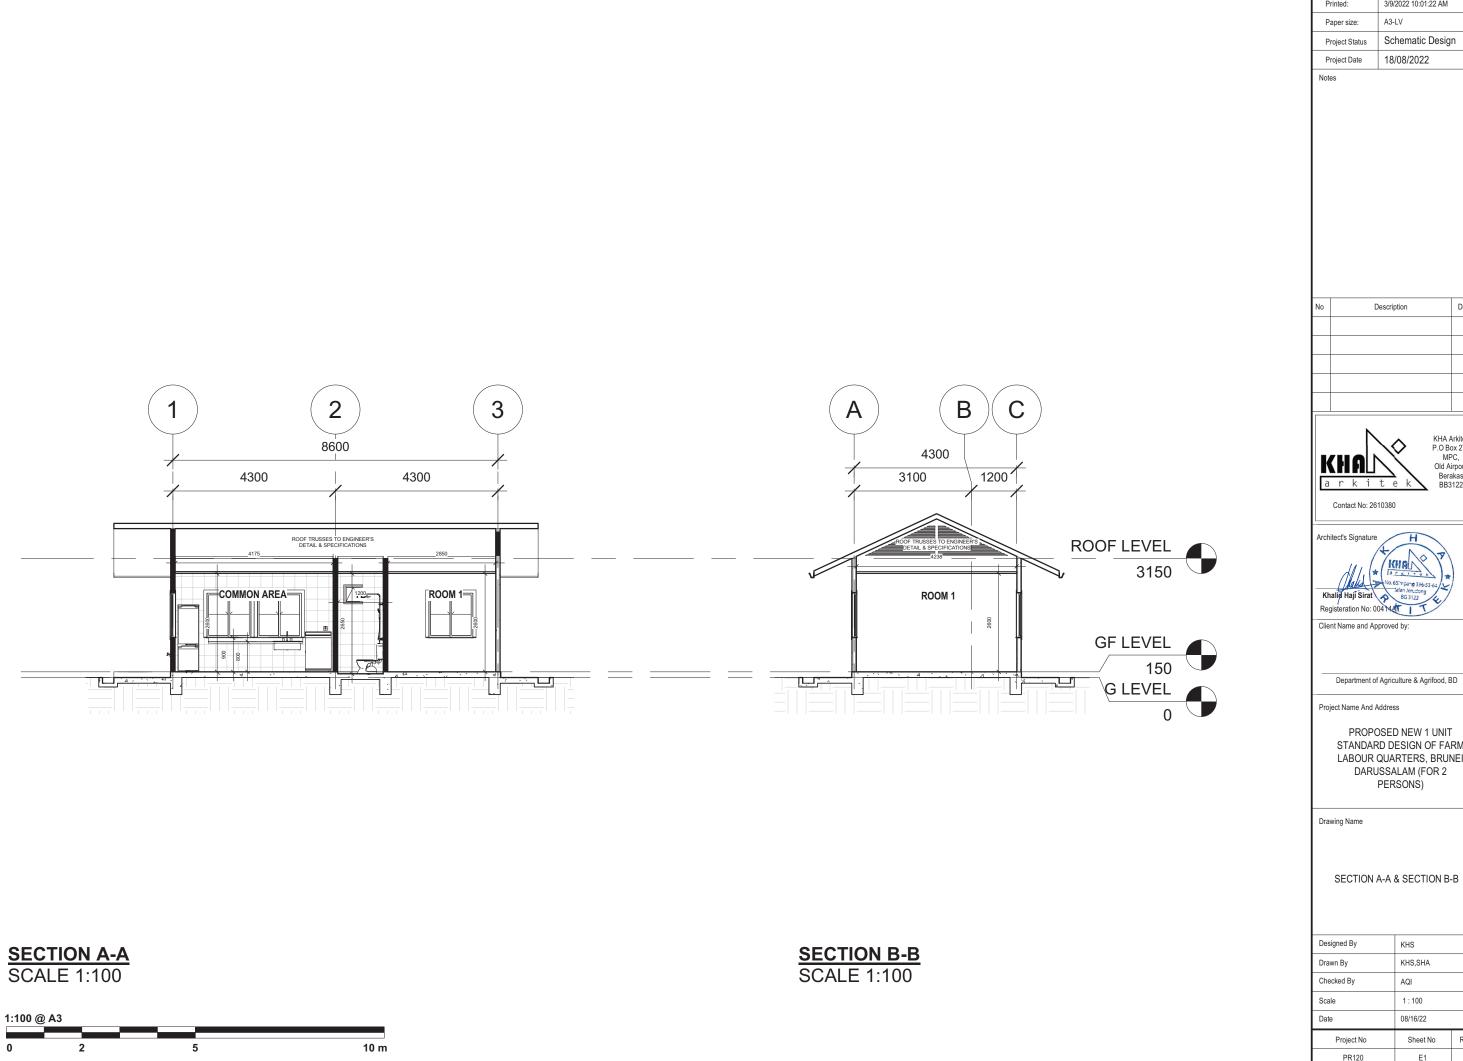


Printed: 3/9/2022 10:01:22 AM Schematic Design

No	Description	Date



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Designed By	KHS	
Drawn By	KHS,SHA	
Checked By	AQI	
Scale	1:100	
Date	08/16/22	
Project No	Sheet No	Rev.
PR120	E1	

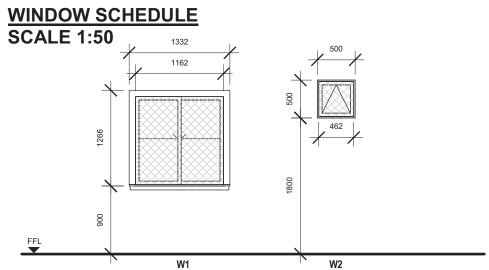

			W1		W2			
	WINDOW SCHEDULE							
	WINDOW SCHEDOLE							
CC	ODE	Nos	Location	Level	Sill Height	Width	Height	Description

W1	5	COMMON AREA	GF LEVEL	900	1200	1200	TWO PANEL SLIDING ALUMINIUM FRAMED WINDOW W/6MM THK. CLEAR GLASS W/ MOSQUITO NET COVER COMPLETE W/ ACCESSORIES TO MANUFACTURERS DETAILS
W1	2	ROOM 1	GF LEVEL	900	1200	1200	TWO PANEL SLIDING ALUMINIUM FRAMED WINDOW W/6MM THK. CLEAR GLASS W/ MOSQUITO NET COVER COMPLETE W/ ACCESSORIES TO MANUFACTURERS DETAILS
W2	1	ТВ	GF LEVEL	1800	500	500	TOP HUNG ALUMINIUM FRAMED WINDOW W/6MM THK. CLEAR GLASS W/ MOSQUITO NET COVER COMPLETE W/ ACCESSORIES TO MANUFACTURERS DETAILS

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Paper size:	A3-LV
Project Status	Schematic Design
Project Date	18/08/2022

Note

No	Description	Date



Contact No: 2610380

Architect's Signature

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Client Name and Approved by:

Department of Agriculture & Agrifood, BD

Project Name And Address


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Drawing Name

WINDOW SCHEDULE

Designed By	KHS	
Drawn By	KHS,SHA	
Checked By	AQI	
Scale	1:50	
Date	08/25/22	
Project No	Sheet No	Rev.
PR120	F1	

DOOR SCHEDULE SCALE 1:50

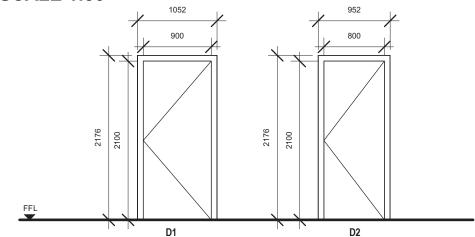

	וט		DZ						
	DOOR SCHEDULE								
CODE	Nos Location	Level	Width	Height	Description				

D1	2	COMMON AREA	GF LEVEL	900	2100	SINGLE LEAF SOLID FIRE RATED DOOR TO MANUFACTURER'S DETAIL
D2	1	TB	GF LEVEL	800	2100	SINGLE LEAF LAMINATED SOLID DOOR TO MANUFACTURER'S DETAIL

NOTES: ANY DOOR THAT OPEN DIRECTLY TO THE OUTSIDE SHALL BE PROVIDED WITH INSECT SCREEN TO MANUFACTURERS DETAIL AND SPECIFICATION

IRONMONGERIES SCHEDULE

							HARDWAR	RE SET		
					DORMA Stainless Steel Butt Hinge 2BB Stainless Steel, (4"x 3.0" x 2.5mm) or equivalent	DORMA Knob Type Lockset CK800 Series 60mm Grade 2 – US32D Finish CK 801 Entrance Function or equivalent	DORMA Knob Type Lockset CK800 Series 60mm Grade 2 – US32D Finish CK 803 Privacy Function or equivalent	ELITE 500 Door Stopper S066701 or equivalent	DORMA Barrel Bolt 2750x300MM SNP or equivalent	UNITY DGS01 stainless steel security door guard
	DOOR	WIDTH x HEIGHT	QTY	DOOR TYPE	H1	L1	L2	A1	A2	A3
	SCHEDULE	(mm)		5001(1112	HINGES	LOCKSETS		ACCESSORIES		
GROUND FLOOR										
COMMON AREA	D1	900 x 2100mm	1	FIRE DOOR SINGLE	3	•		•		•
ROOM 1	D1	900 x 2100mm	1	FIRE DOOR SINGLE	3	•	•	•		
ТВ	D2	800 x 2100mm	1	LAMINATED SOLID DOOR SINGLE	3		•		•	

CODE	CATEGORIES	IMAGES
H1	HINGES	
L1	LOCKSET	960
L2	2001.02.	1000
NO.1		-
NO.2	ACCESSORIES	2
NO.3		

NOTES: BRAND MAY VARIES TO SUIT USER'S SAFETY AND THE ARCHITECT'S APPROVAL

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Project Status	Schematic Design		
Project Date	18/08/2022		

Notes

No	Description	Date

KHA Arkitek P.O Box 272 MPC, Old Airport, Berakas BB3122



Contact No: 2610380

Architect's Signature

No. 65: mpang 396-33-64.

Malan Jenudong

Khalid Haji Sirat

Registeration No: 00414Ar

Client Name and Approved by:

Department of Agriculture & Agrifood, BD

Project Name And Address

PROPOSED NEW 1 UNIT STANDARD DESIGN OF FARM LABOUR QUARTERS, BRUNEI DARUSSALAM (FOR 2 PERSONS)

Drawing Name

DOOR & IRONMONGERY SCHEDULE

Designed By	KHS			
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Checked By	AQI			
Scale	1:50			
Date	09/02/22			
Project No	Sheet No	Rev.		
PR120	F2			

VENTILATION SCHEDULE

ROOM/SPACE	AREA	72111127111311		LIGHTING	WINDOWS &		
ROOM/SFACE	(MSQ)	REQUIRED (10%)	PROVIDED	PROVIDED	DOORS	MECHANICAL	
GROUND FLOOR							
COMMON AREA	19 MSQ	1.9 MSQ	6.8 MSQ	5.6 MSQ	W1(5)	SPLIT AC , CEILING FAN, EXHAUST FAN	
ТВ	3 MSQ	0.3 MSQ	0.2 MSQ	0.13 MSQ	W2(1)	EXHAUST FAN	
ROOM 1	12 MSQ	1.2 MSQ	2.7 MSQ	2.22 MSQ	W1 (2)	CEILING FAN	

MATERIAL SCHEDULE

ADEA		FLO	OR				W	ALL					CEILI	NG	RO	OF
AREA	F1	F2	F3	F4	W1	W2	W3	W4	W5	W6	W7	C1	C2	C3	R1	R2
GROUND FLOOR						•										
APRON				•												
COMMON AREA	•	•					•	•				•		•	•	•
COMMON AREA (KITCHEN)	•	•	•		•	•			•	•	•	•		•	•	•
ТВ	•	•	•		•	•			•	•	•		•	•	•	•
ROOM 1	•	•					•	•				•		•	•	•

CODE	FLOOR FINISHES
F1	300mm X 300mm homogeneous non-slip tile, colour and pattern to be decided by client
F2	Grouting
F3	Waterproofing Treatment or equivalent. All application shall be in accordance to manufacturer specification
F4	Cement Screed to level

Notes: All potentinally wet area shall be anti slip surface tiles

CODE	WALL FINISHES
W1	25mm Thick Plaster
W2	Brick Wall
W3	ICI paint to manufacturer specification or equivalent, colour and pattern to be decided by client
W4	Light Dry Wall with metal framing
W5	300mm x 300mm Ceramic tiles, colour and pattern to be decided by client
W6	Bonding agent
W7	Grouting

Notes: For External Walls, dry wall complete with metal framing; one side lined with gypsum board and one side with cement board.

CODE	CEILING FINISHES
C1	12mm Gypsum board with metal framing. ICI paint to manufacturer specification, colour and pattern to be decided by client
C2	6mm Cement board with metal framing
C3	ICI paint to manufacturer specification or equivalent

CODE	ROOF FINISHES
R1	Colour Lok clip-on system profile or equivalent with 0.53/054mm thickness including joists and purlins and accessories to manufacturer and installation specification, colour and pattern to be decided by client
R2	Waterproofing, all application and installation shall be in accordance to manufacturer specification

SANITARYWARE & FITTINGS SCHEDULE

MATERIAL CODE NO.	WATER CLOSET	LAVATORY	FAUCET			SHOWER FAUCET	PAPER HOLDER	TOWEL BAR	MIRROR	ANAL SPRAY / WASHLET	SINK	FLOOR TRAP
	01	01	01	02	03	01	01	01	01	01	01	01
GROUND F	LOOR											
EXTERIOR	-	-	-	2	-	-	-	-	-	-	-	-
COMMON AREA	-	-	-	1	1	-	-	-	-	-	1	-
ТВ	1	1	1	-	-	1	1	1	1	1	-	3
TOTAL	1	1	1	3	1	1	1	1	1	1	1	3

CODE	WATER CLOSET
01	SHOWY "WASHDOWN" 2-PIECE CLOSET (630 X 440 X 775MM) S-trap, 250mm Roughing-in. p-trap, 180mm Rouching-in or equivalent
CODE	LAVATORY
01	SHOWY-6851 WASHBASIN C/W FULL PEDESTAL (520 X 440 X 800MM) or equivalent
CODE	FAUCET
01	SHOWY-3006 "HIGHWAY" EXCLUSIVE S/L BASIN MIXER C/W SWIVEL SPOUT Stock Code: SHOWY-3006-000 or equivalent
02	SHOWY-2908 "BUTTERFLY" BIB TAP C/W 1/2" NOZZLE Stock Code: SHOWY-1755-000 or equivalent
03	SHOWY-3110-3000 "HIGH-GRADE" METAL SINGLE LEVER SINK TAP. Stock Code: SHOWY-3110-001 or equivalent
CODE	SHOWER FAUCET
01	SHOWY-3011-3001(R) "CAUSEWAY" 3-WAY LONG BATH MIXER C/W 3041 ABS ROUND SHOWER ROSE & 3039-SH HAND SHOWER Stock Code: SHOWY-3011-013 or equivalent

CODE	PAPER HOLDER
01	SHOWY-7067-000 "LUXI" S/S STAINLESS STEEL PAPER HOLDER or equivalent
CODE	TOWEL BAR
01	SHOWY-7142-000 SUS304 S/STEEL DOUBLE TOWEL BAR 600 x 120 x 55mm or equivalent
CODE	MIRROR
01	SHOWY-2998-000 480MM X 350MM SILVER COATED MIRROR or equivalent
CODE	SHOWER SPRAY / WASHLET
01	SHOWY-2480-011 "JOPAN" CHROME BIDET SPRAY C/W SHOWY-2453 120CM SILVER PVC HOSE & SHOWY-6322-000 "L" QUARTER-TURN ANGLE COCK WITH BIDET SPRAY HOLDER or equivalent
CODE	SINK
01	SHOWY-2948-000 "DAGENT" S/S LAY-ON LAUNDRY SINK (600 X 500 X 250MM) or equivalent
CODE	FLOOR TRAP
01	SHOWY-2774-000 6" X 6" CHROME ALLOY ADAPTABLE FLOOR TRAP GRATING or equivalent

CODE	CATEGORIES	IMAGES
NO.1	WATER CLOSET	
NO.1	LAVATORY	
NO.1		
NO.2	FAUCET	
NO.3		
NO.1	SHOWER FAUCET	*

CODE	CATEGORIES	IMAGES
NO.1	PAPER HOLDER	
NO.1	TOWEL BAR	
NO.1	MIRROR	
NO.1	SHOWER SPRAY / WASHLET	
NO.1	SINK	
NO.1	FLOOR TRAP	明德

<u>NOTES:</u> BRAND MAY VARIES TO SUIT USER'S COMFORT AND THE ARCHITECT'S APPROVAL

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Paper size:	A3-LV
Project Status	Schematic Design
Project Date	18/08/2022

Not

0	Description	Date



KHA Arkitek P.O Box 272 MPC, Old Airport, Berakas BB3122

Contact No: 2610380

Client Name and Approved by:

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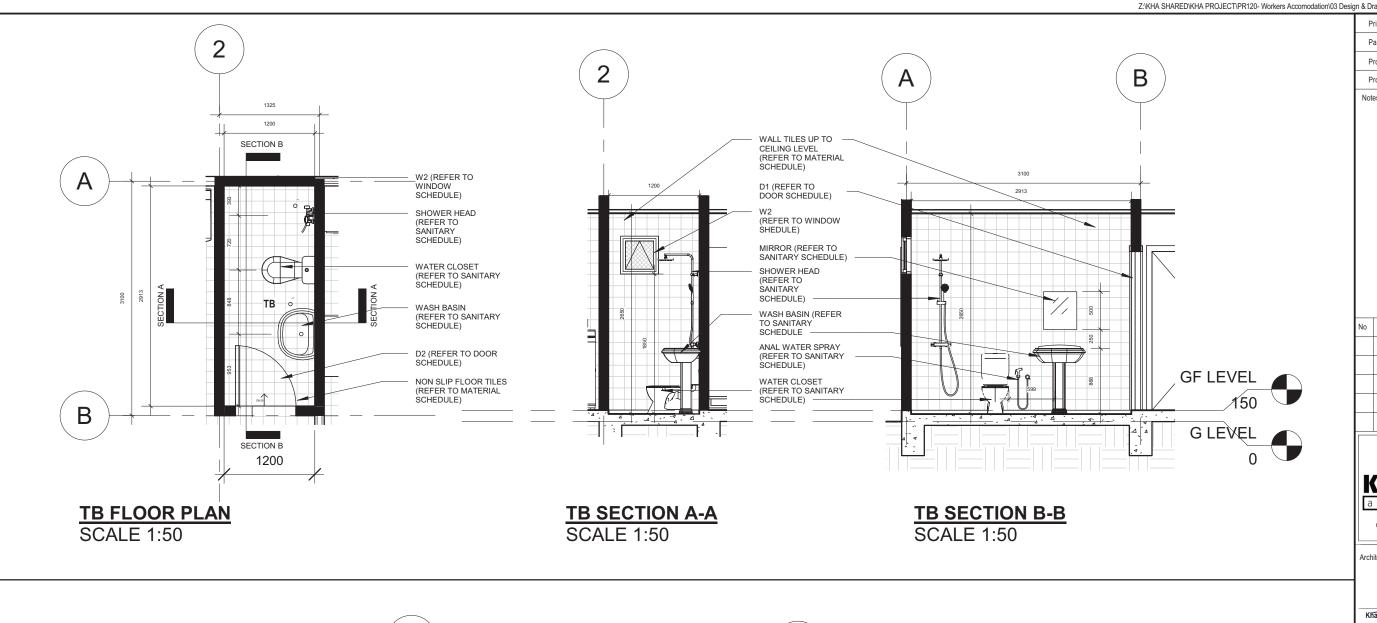
Project Name And Address


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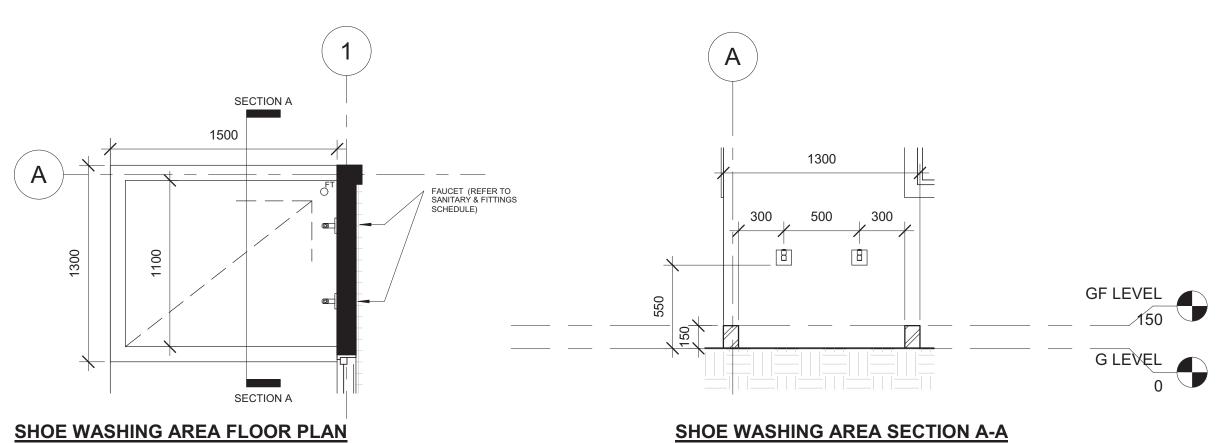
Drawing Name

VENTILATION, MATERIAL, SANITARY & FITTING SCHEDULES

Designed By	KHS	
Drawn By	KHS,SHA	
Checked By	AQI	
Scale	As indicated	
Date	08/25/22	
Project No	Sheet No	Rev.
PR120	F3	





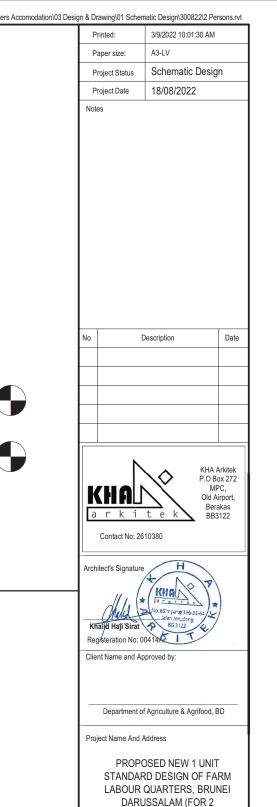

SCALE 1:25


SCALE 1:25


Drawing Name

TB & SHOE WASHING AREA DETAILS

PERSONS)

Designed By	KHS	
Drawn By	KHS,SHA	
Checked By	AQI	
Scale	As indicated	
Date	08/25/22	
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PR120	G1	

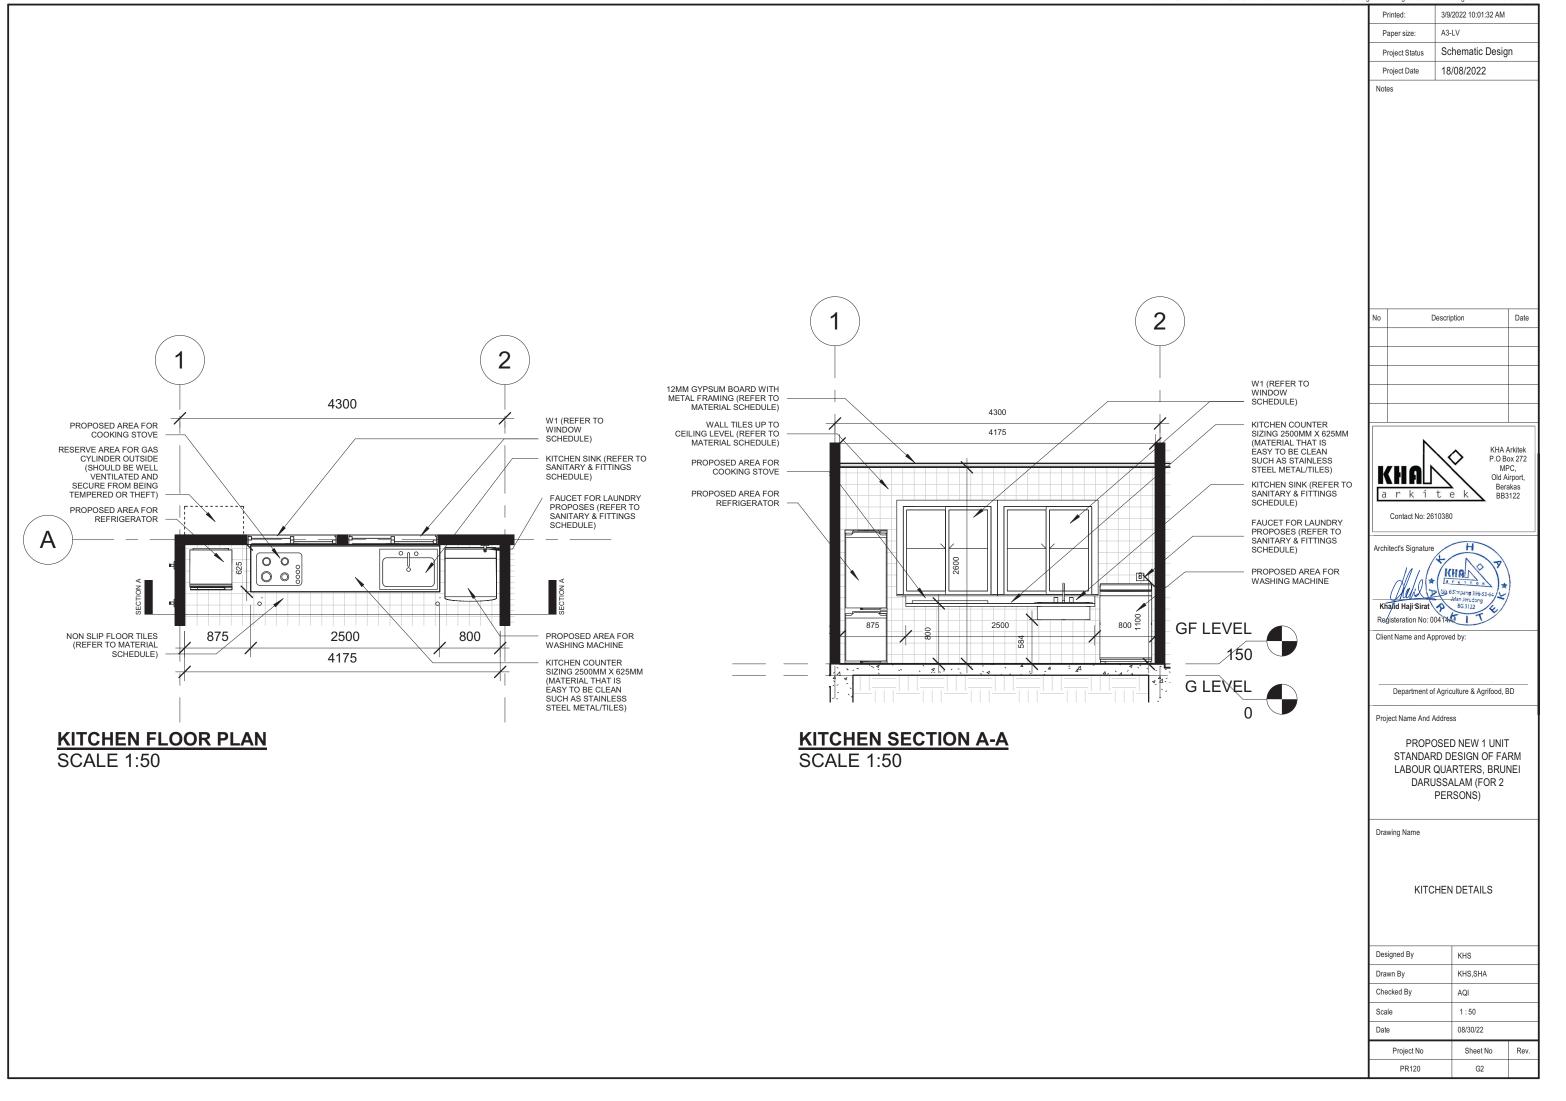

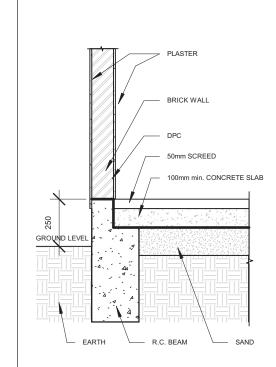

TYPICAL DPC DETAILS (SOLID WALL) SCALE 1:20


GYPSUM BOARD CEMENT BOARD METAL STUD FRAMING METAL TRACK FRAMING BOLTED TO FLOOR SLAB 50mm SCREED SEALANT 100mm min. CONCRETE SLAB GROUND LEVEL R.C. BEAM

TYPICAL DPC DETAILS (DRY WALL) **SCALE 1:20**

NOTES: DRY WALL CAN BE OPTED FOR WALL SANDWICH PANEL TO THE MANUFACTURER'S DETAILS AND SPECIFICATIONS

*For External Walls, dry wall complete with metal framing; one side lined with gypsum board and one side with cement board.

*For Internal Walls, dry wall complete with metal framing; both sides lined with gypsum board.

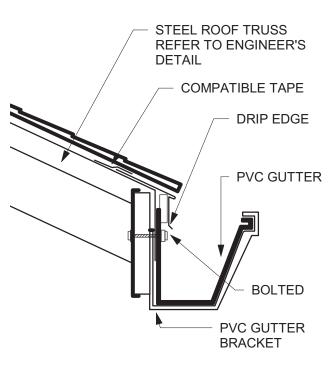

GUTTER DETAILS SCALE 1:5

Printed: 21/9/2022 4:39:24 PM Paper size: Schematic Design Project Status 18/08/2022 Project Date

Notes

Date Description

KHA Arkitek

Berakas



Contact No: 2610380

Khalid Haji Sirat Registeration No: 00414

Client Name and Approved by:

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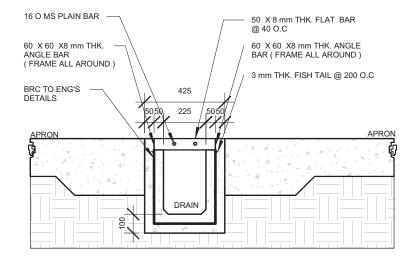
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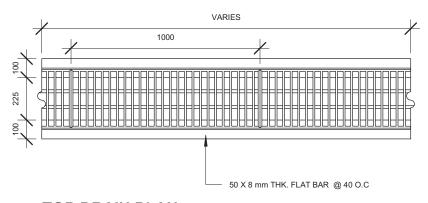
DOOR JAMB, TYPICAL DPC, GUTTER AND SURFACE DRAIN DETAILS

Designed By	KHS	
Drawn By	KHS,SHA	
Checked By	AQI	
Scale	As indicated	
Date	08/26/22	
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PR120	G3	

DETAIL OF SURFACE DRAIN WITH HEAVY DUTY MS GRATING COVER



SECTIONAL 225MM SCALE 1:20



TOP DRAIN PLAN

DOOR JAMB
DETAIL
SCALE 1:5

100

R.C LINTEL

H.W ARCHITRAVE

H.W DOOR FRAME

SCHEDULE

CARPET)

H.W DOOR STOPPER

FLOOR FINISH (TILE /


18MM X 50MM DECORATIVE

25MM X 50MM H.W BACKING

50MM X 150MM DECORATIVE

13MM X 50MM DECORATIVE

DECORATIVE SOLID TIMBER DOOR REFER TO DOOR

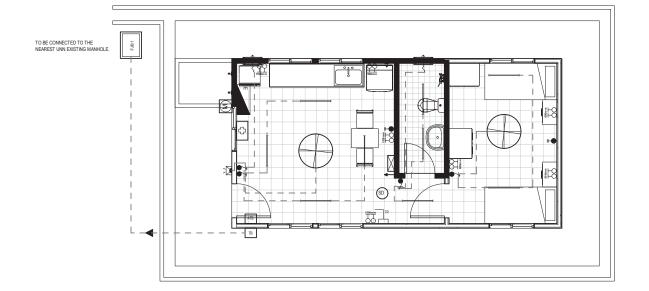

	ELECTRICAL SYMBOLS	
	1X LED TUBE LIGHTING	
	WALL LIGHTING (WALL MOUNTED & WEATHERPROOF LIGHT FIXTURE)	
6	ONE GANG SINGLE TOGGLED SWITCH POINT	
\$	ONE GANG TWO TOGGLED SWITCH POINT	
\$	ONE GANG THREE TOGGLED SWITCH POINT	
660mm	2 x 13A SOCKET OUTLET at 600mm HIGH ABOVE FINISHED FLOOR LEVEL. FOR EXTERNAL AREA, WATER PROOF BOX OR COVER SHALL BE USED	
1500m m	2 x 13A SOCKET OUTLET at 1500mm HIGH ABOVE FINISHED FLOOR LEVEL. FOR EXTERNAL AREA, WATER PROOF BOX OR COVER SHALL BE USED	
#	15A SWITCH SOCKET OUTLET	
	CEILING FAN	
E	ELECTRICAL DISTRIBUTION BOARD	
M	PRE-PAID ELECTRIC METER	
~	300mm Dia, EXHAUST FAN PT.COME WITH FUSE CONNECTIOPN UNIT	
TV	TV SOCKET POINT	

	JPB SYMBOLS	
<u></u>	2.5KG (CO2) DRY EXTINGUISHER	
	FIRE BLANKET (1x1.2x1.8m)	
SD	SMOKE DETECTOR	
Т	ELECOMMUNICATION SYMBOLS	
TiP	TELEPHONE OUTLET	
АТВ	ACCESS TERMINATION BOX	
ТВ	TERMINATION BOX	
	FIRST AID SYMBOLS	
Ç	FIRST AID KIT BOX	

Printed:	3/9/2022 10:01:36 AM
Paper size:	A3-LV
Project Status	Schematic Design
Project Date	18/08/2022

No	Description	Date	



Contact No: 2610380

Client Name and Approved by:

Department of Agriculture & Agrifood, BD

Project Name And Address

PROPOSED NEW 1 UNIT STANDARD DESIGN OF FARM LABOUR QUARTERS, BRUNEI DARUSSALAM (FOR 2 PERSONS)


Drawing Name

ELECTRICAL LAYOUT

Designed By	KHS	
Drawn By	KHS,SHA	
Checked By	AQI	
Scale	1:100	
Date	09/02/22	
Project No	Sheet No	Rev.
PR120	К	

GROUND FLOOR ELECTRICAL LAYOUT PLAN SCALE 1:100

10 m

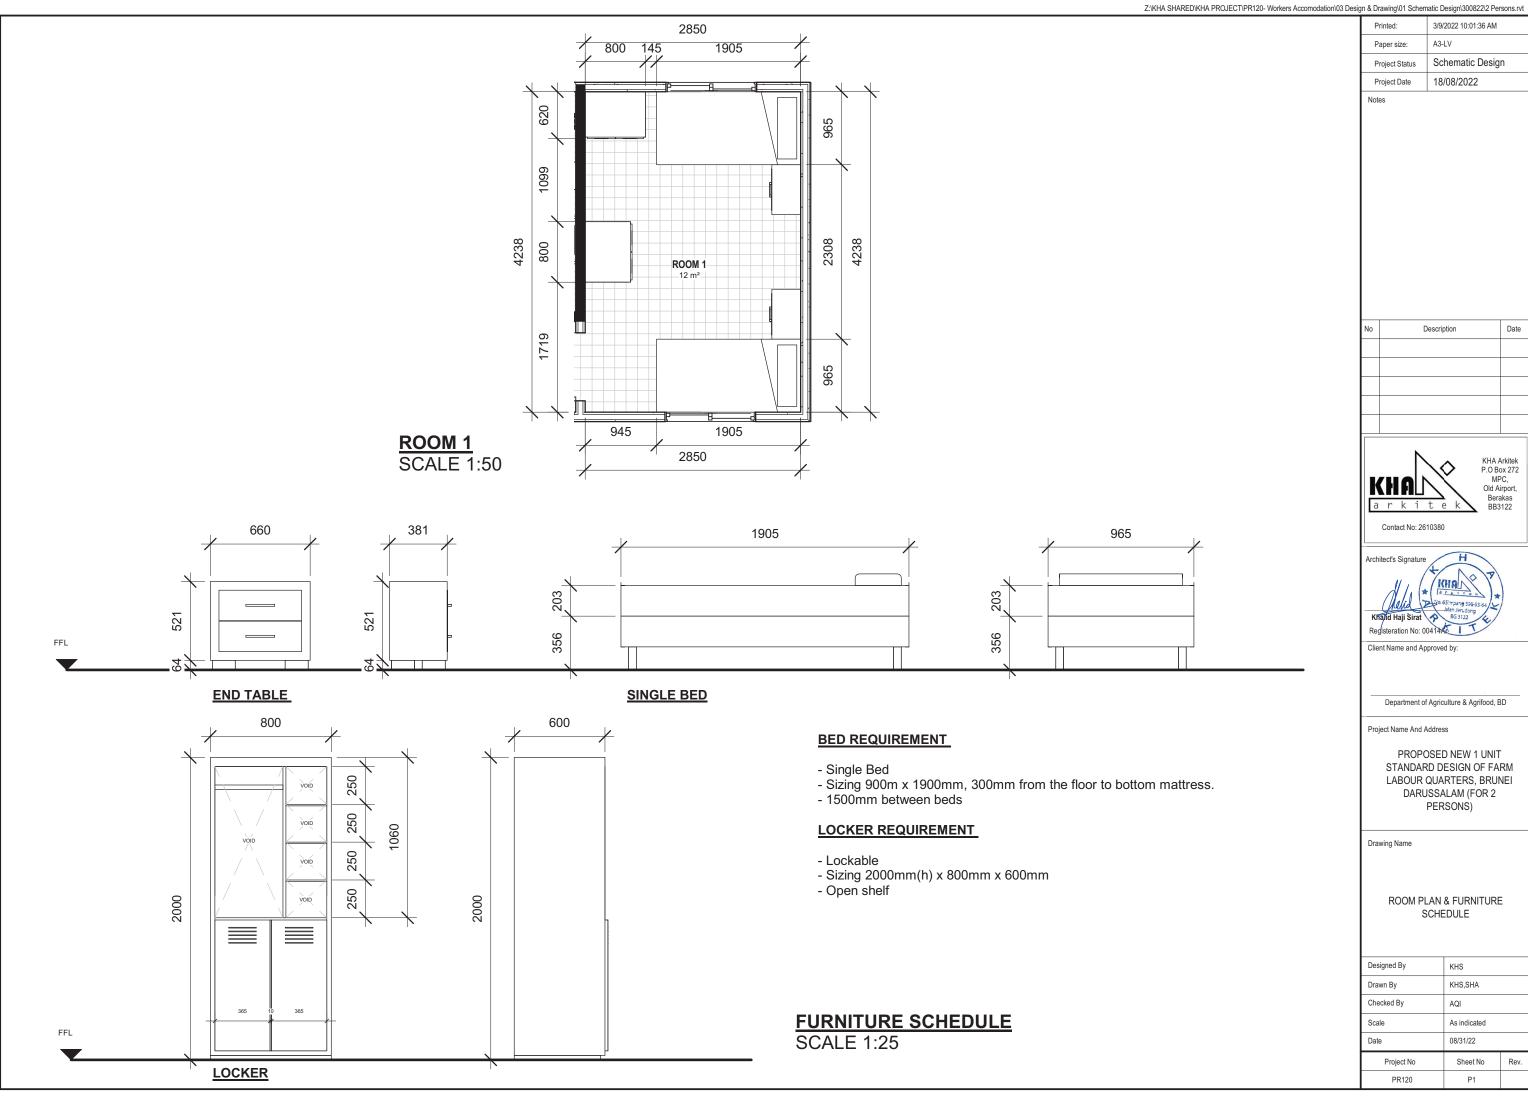

Printed:	3/9/2022 10:01:36 AM
Paper size:	A3-LV
Project Status	Schematic Design
Project Date	18/08/2022

No	Description	Date

PROPOSED NEW 1 UNIT STANDARD DESIGN OF FARM LABOUR QUARTERS, BRUNEI DARUSSALAM (FOR 2

Designed By	KHS				
Drawn By	KHS,SHA				
Checked By	AQI				
Scale	As indicated				
Date	-				
Project No	Sheet No	Rev.			
PR120	P1				

PROPOSED NEW 1 UNIT STANDARD DESIGN OF FARM LABOUR QUARTERS, BRUNEI DARUSSALAM (FOR 2 PERSONS)

		LIST OF D	RAWINGS	
	DESCRIPTIONS	DRAWING NO.	REVISION NO.	REMARKS
$\left\{ \right\}_{1}^{1}$	LIST OF DRAWINGS	SBC/Q366/AFLQ/2P/RC/L - 100	2	
2	GENERAL NOTES	SBC/Q366/AFLQ/2P/RC/G-100		
3	150x150mm R.C PRECAST PILEFOUNDATION LAYOUT PLAN	SBC/Q366/AFLQ/2P/RC/CS-100		
4	PAD FOOTING FOUNDATION LAYOUT PLAN [ALLOWABLE STRESS OF SOIL 100 KN/m²]	SBC/Q366/AFLQ/2P/RC/CS-101		
5	PAD FOOTING DETAILS [ALLOWABLE STRESS OF SOIL 100 KN/m²]	SBC/Q366/AFLQ/2P/RC/CS-101A		
6	PAD FOOTING FOUNDATION LAYOUT PLAN [ALLOWABLE STRESS OF SOIL 150 KN/m²]	SBC/Q366/AFLQ/2P/RC/CS-102		
7	PAD FOOTING DETAILS [ALLOWABLE STRESS OF SOIL 150 KN/m²]	SBC/Q366/AFLQ/2P/RC/CS-102A		
8	PAD FOOTING FOUNDATION LAYOUT PLAN [ALLOWABLE STRESS OF SOIL 200 KN/m²]	SBC/Q366/AFLQ/2P/RC/CS-103		
9	PAD FOOTING DETAILS [ALLOWABLE STRESS OF SOIL 200 KN/m²]	SBC/Q366/AFLQ/2P/RC/CS-103A		
10	COLUMN SCHEDULE	SBC/Q366/AFLQ/2P/RC/CS-104		
11	GROUND FLOOR BEAM LAYOUT PLAN	SBC/Q366/AFLQ/2P/RC/CS-200		
12	GROUND FLOOR BEAM DETAILS	SBC/Q366/AFLQ/2P/RC/CS-201		
13	ROOF BEAM LAYOUT PLAN	SBC/Q366/AFLQ/2P/RC/CS-300		
14	ROOF BEAM DETAILS	SBC/Q366/AFLQ/2P/RC/CS-301		
15	ROOF TRUSSES LAYOUT PLAN	SBC/Q366/AFLQ/2P/RC/CS-400		
16	ROOF TRUSS SECTION(FOR ROOF TRUSS TO REINFORCE CONCRETE BEAM CONNECTION)	SBC/Q366/AFLQ/2P/RC/CS-401	}	
17	ROOF TRUSS SECTION (FOR ROOF TRUSS TO REINFORCE CONCRETE BEAM CONNECTION)	SBC/Q366/AFLQ/2P/RC/CS-402	}	
	MISCELLANEOUS DETAILS - 1	SBC/Q366/AFLQ/2P/RC/MISC-100		
19	MISCELLANEOUS DETAILS - 2	SBC/Q366/AFLQ/2P/RC/MISC-101		



	SERI BUMI CONSULTANT	CLIENT:					DESIGNED BY	THAN ZAW TUN		SCALE:	пт.е:	JOB NO:	
(SDC)	CIVIL & STRUCTURAL ENGINEERING CONSULTANT No: 14. 2nd FLOOR, BLOCK A. GADONG CENTRAL, SIMPANG						DRAWN BY	SAI	10		LIST OF DRAWINGS	SHEET NO:	
	21, JALAN GADONG, BSB, BRUNEI DARUSSALAM TEL: 673-2427275 FAX: 673-2427279 E-MAIL: sbc.brunei@gmail.com						CHECKED BY	MD. YUNUS		N.T.S	PROJECT: PROPOSED NEW 1 UNIT STANDARD DESIGN OF FARM LABOUR QUARTERS,	DRAWING NO:	REV:
	-		NO.	AMENDMENTS	BY	DATE	APPROVED BY		20/09/202	2	BRUNEI DARUSSALAM (FOR 2 PERSONS)	SBC/Q366/AFLQ/2P/RC/L - 100	0 2

GENERAL

- 1.1 SETTING OUT:
 - ALL DIMENSIONS MEASURED ON SITE SHALL BE CHECKED AND CONFIRMED WITH RELEVANT ARCHITECTURAL, M&E, CIVIL AND STRUCTURAL DRAWINGS.
- 1.2 ANY DISCREPANCIES BETWEEN ARCHITECTURAL, C&S AND M&E DRAWINGS SHALL BE REFERRED TO PROJECT ARCHITECT OR STRUCTURAL ENGINEER OR
- 1.3 PLEASE NOTE THAT THE ARCHITECTURAL DRAWINGS GRID LINE AND STRUCTURAL DRAWINGS GRID LINES HAVE BEEN PURPOSELY OFF-SET TO EASE CONSTRUCTION ON STRUCTURAL MEMBERS.
- 2. STANDARDS & CODE OF PRACTICE
- 2.1 BS 8110 : 1985 STRUCTURAL USE OF CONCRETE
 2.2 PBD 12 : 2008 BUILDING GUIDELINES AND REQUIREMENTS
- 2.3 BS 4449: 1978 HOT ROLLED STEEL BARS FOR THE REINFORCEMENT OF CONCRETE
- 3. CONCRETE
- 3.1 CONCRETE STRENGTH: 25 N/mm² (GRADE 25) UNLESS OTHERWISE
 - STATED LEAN CONCRETE - 15 N/mm² - 25 N/mm² COLUMN - 25 N/mm² 25 N/mm²
- 3.2 CONCRETE COVER TO ALL REINFORCEMENT INCLUDING LINKS SHALL MEET THE 2-HOUR FIRE RATING & AS STATED BELOW (UNLESS OTHERWISE STATED) COLUMNS: 30mm
- BEAMS PILE CAPS : 75mm
- 3.3 CONCRETE CURING: TO BE CARRIED OUT BY SPRAYING WITH WATER AND COVERING WITH EITHER GUNI SACKS OR PLASTIC
- 3.4 ANY COLD JOINTS AND HACKED CONCRETE SURFACE SHALL BE APPLIED WITH APPROVED BONDING AGENT BEFORE POURING NEW
- 3.5 50mm (MINIMUM) THICK BLINDING LEAN CONCRETE SHALL BE PROVIDED BENEATH FOOTINGS, GROUND BEAMS AND ALL GROUND FLOOR SLABS
- 4. STEEL REINFORCEMENT
- 4.1 THE MINIMUM YIELD STRENGTH OF STEEL REINFORCEMENT (WITH DENOTATION "T")FOR HIGH TENSILE DEFORMED BAR(TYPE 2 - 460 N/mm², STEEL FABRIC - 485 N/mm² (UNLESS OTHERWISE STATED.
- 4.2 THE MINIMUM YIELD STRENGTH OF STEEL REINFORCEMENT
- 5. ALL WATER RETAINING STRUCTURE OR WET AREAS SHALL BE
- 6. IF REQUIRED R.C LINTEL BEAM OF SIZES 150 X 200 REINFORCED WITH 2T12 (T&B) & R6 -150 LINKS SHALL BE PROVIDED TO ALL DOORS AND WINDOWS. STIFFENER, COLUMN SIZES 150X150 TO 200X200 REINFORCED WITH 4T12 & T10-150 LINKS SHALL BE PROVIDED IF REQUIRED. (FOR EG. ON WALL OF MORE THAN 3.5m IN HORIZONTAL LENGTH OR
- 7. INCORPORATING OF M & E REQUIREMENTS IN STRUCTURAL DRAWINGS: THE CONTRACTOR TO PREPARE DETAILED SHOP DRAWINGS INCORPORATING ALL M & E REQUIREMENTS, OPENINGS ETC INTO THE STRUCTURAL DRAWINGS AND OBTAIN THE PROJECT STRUCTURAL ENGINEER APPROVAL BEFORE PROCEEDING WITH ANY FORM OF PERMANENT CONSTRUCTION WORKS. THE CONTRACTOR SHALL RESOLVE ALL DISCREPANCIES WITH ENGINEERS REGARDING M & E WORKS PRIOR TO CONCRETING.

8. NOTES FOR COMPACTION WORKS OF SUB-BASE AND SUB-GRADE.

- ALL SUB-GRADE AND SUB-BASE LAYING WORKS SHALL BE WELL COMPACTED TO OVER 95% CBR.
- MINIMUM OF FOUR NUMBER OF DRY FIELD DENSITY TESTS AND CBR TESTS SHALL BE CONDUCTED ON COMPACTED SUBGRADES AND SUB-BASE BEFORE CARRYING OUT ANY PERMANENT WORKS SUCH AS CONCRETING OF ACCESS ROAD, GARAGE NON-SUSPENDED FLOOR SLABS & HARD STANDINGS, ETC. THE TESTS RESULTS SHALL BE SUBMITTED TO CIVIL AND STRUCTURAL CONSULTANT ENGINEER FOR REVIEW AND APPROVAL TO PROCEED WITH PERMANENT WORKS (IF APPLICABLE BASIS ONLY).

9.REMOVAL OF FORMWORK

A) THE TIME FOR THE REMOVAL OF FORMWORKS IS TO BE SUBJECTED TO ENGINEER'S APPROVAL,
BUT THE FOLLOWING MAY BE TAKEN AS A GUIDE TO MINIMUM TIMES APPLICABLE UNDER NORMAL CIRCUMSTANCES:

E	BUT THE FULLOWING WAY BE TAKEN AS A GU	JIDE TO MINIMUM	I IIVIES F
	SIDE OF COLUMNS/PIERS,WALLS AND BEAMS	3 DAYS	
	SOFFIT OF SLABS (PROPS LEFT UNDER)	14 DAYS	
	PROPS OF SLABS	28 DAYS	
	SOFFIT OF BEAMS (PROPS LEFT UNDER)	14 DAYS	
	PROPS TO SOFFIT OF BEAMS	28 DAYS	

- B) SHUTTERING AND CENTERING SHALL BE REMOVED BY GRADUAL EASING WITHOUT JARRING, AND ONLY IN THE PRESENCE OF A COMPETENT SUPERVISER, BEFORE REMOVAL OF THE SHUTTERING, THE CONCRETE SHALL BE EXAMINED, AND REMOVAL SHALL PROCEED ONLY IF THE CONCRETE HAS ATTAINED SUFFICIENT STRENGTH TO SUPPORT ITS OWN WEIGHT AND ANYCONSTRUCTIONAL OR OTHER LOADS LIKELY TO COME UPON IT. IF ANY LOADING IN EXCESS OF THE DESIGN LOAD IS ANTICIPATED, APPROVED PROPS SHALL BE PROVIDED AFTER REMOVAL OF SHUTTERING
- C) TO ENSURE THAT THE CONSTRUCTIONAL LOADS OF A FLOOR ARE SHARED BY AT LEAST TWO FLOORS BELOW IT, THE PROPS TO THE BEAMS AND SLABS OF A FLOOR SHALL NOT BE REMOVED UNTIL THE FLOOR ABOVE THE FLOOR IN QUESTION, IS STRONG ENOUGH TO SUPPORT ITSELF.

10. GENERAL NOTES FOR PILING WORKS

- ALL PILES TO BE USED FOR THIS PROJECT SHALL BE OF BRUNEI DARUSSALAM MINISTRY OF DEVELOPMENT'S APPROVED TYPES AND BRAND NAMES OR AS PER S.O.'S APPROVAL.
- THE CONTRACTOR SHALL SUBMIT TO THE ENGINEER FOR APPROVAL, BEFORE ANY PILING WORK IS STARTED, DETAILS OF :-
- PILE DRIVER INCLUDING SIZE OF HAMMER AND DROP
- CONTRACTOR'S CALCULATIONS OF SETS, CALCULATED USING THE HILEY FORMULA.
- PROPOSED PROGRAM AND SEQUENCE OF PILE DRIVING INCLUDING
- NO PILING SHALL COMMENCE UNTIL THE SET VALUES SUBMITTED BY THE CONTRACTOR
- ARE APPROVED IN WRITING BY THE ENGINEER.
 THE CALCULATED SETS SHALL ONLY BE USED AS A GUIDE FOR DRIVING AND THE SET SHALL BE CONFIRMED BY THE IN-SITU PILE TEST.
- HOWEVER, PILE HYDRAULIC JACKING TO TWICE THE SAFE WORKING LOAD (MINIMUM) SHALL BE USED IF PILE HAMMERING ACTIVITIES CAUSES DISTURBANCES AND DISTRESS (EXCESSIVE VIBRATIONS) TO SURROUNDING BUILDINGS

11. GENERAL NOTES FOR R.C PILES

R.C PILES

- ALL REINFORCED CONCRETE (R.C.) PRECAST PILES SHALL BE 150MM X 150MM REINFORCED CONCRETE PRECAST PILES OR AS PER SPECIFIED IN THE DRAWINGS
- CONCRETE GRADE SHALL BE GRADE 45 MINIMUM FOR NORMAL R.C. PRECAST PILES.
- THE ALLOWABLE SAFE BEARING CAPACITY OF EACH R.C. PRECAST PILES POIN SHALL BE 25 TONNES.
- THE EXPECTED PENETRATION DEPTH OF EACH PILE POINT IS 6 TO 15 METRES. THIS IS TO BE CONFIRMED DURING PILE DRIVING WORKS. (UNTIL PILE SET IS ACHIEVED UNLESS OTHERWISE STATED)
- THE PILE SET SHOULD BE ACHIEVED WITH THE LAST 10 BLOWS FOR LESS THAN 20mm PENETRATION (PILE HAMMER OF ABOUT ONE TONNE WITH HAMMER DROP OF ABOUT 600mm TO ONE METRE)
- ALL WELDING WORKS FOR JOINING OF PILES SHALL BE CARRIED OUT BY QUALIFIED LICENSED WELDERS
- IF ANY OF THE PILE POINTS DOES NOT PENETRATE 6 METRES DEEP INTO THE GROUND (IF PILE SET IS ACHIEVED AT LESS THAN 6 METRES PENETRATION LENGTH). THE CLIENT OR CONTRACTOR SHALL REPORT TO THE C&S CONSULTANT FOR REDESIGN REQUIREMENT OF THE PILE FOUNDATION.

11a. MILD STEEL TUBULAR PILING

- 11a.1 ALL PILES SHALL BE GRADE 43 SEAMLESS MS TUBES 114.3mm \varnothing x 6.3mm THICK TO B.S. 4848 PART II WITH AN ULTIMATE LOAD CAPACITY OF NOT LESS THAN 240kN.
- 11a.2 ALL PILING WORK SHALL BE CARRIED OUT IN ACCORDANCE TO THE GENERAL SPECIFICATION AS SHOWN IN SPECIFICATION OF MATERIALS AND WORKMANSHIP

12. NOTES FOR PAD FOOTING

- ALL PAD FOOTING CONSTRUCTION SHALL BE REFERRED TO THE PAD FOOTING LAYOUT PLAN N AND DETAILS
- THE DESIGN IS BASED UPON THE GROUND BEARING CAPACITY AT ABOUT 2.0 METRES BELOW EXISTING GROUND LEVEL TO BE 150KN/m
- 3. CONCRETE GRADE 30 SHALL BE USED FOR ALL PAD FOOTING WORKS

13. NOTES FOR BAKAU PILING

- 1. WITH A 1/2 TONNE HAMMER AND DROP OF 900mm. THE FINAL SET SHOULD NOT BE MORE THAN 75/10 BLOWS OR THE SET TO BE FINALISED BY THE ENGINEER DURING THE TEST PILING.
- ALL BAKAU PILES SHOULD BE NOT LESS THAN 75mm Ø (ON AVERAGE), ALL PILES CUT-OFF SHALL BE AT THE LOWEST WATER LEVEL. EXACT LEVEL TO BE DETERMINED ON SITE BY THE ENGINEER
- 3. IF PILE REQUIRED TO BE SPLICED TOGETHER, A TUBULAR SPLICE WITH A HEAVY PIPE 90mm Ø x 600mm LONG x 6mm THICK SHOULD BE USED AT LEAST 4 HOLES SHALL BE PROVIDED IN THE PIPE FOR DRIVING 65mm LONG NAILS SPIKE
- 4. ACTUAL SPACING OF BAKAU PILES TO BE DECIDED ON SITE

14. NOTES FOR SAFETY OF EXISTING UNDER GROUND SERVICES

1. MAIN CONTRACTOR TO CARRY OUT PILOT TRENCHING (ADEQUATE GROUND INVESTIGATION) BEFORE CARRYING OUT ANY EXCAVATION WORKS FOR DRAINAGE WORKS, PILING WOKS AND OTHER WORKS THAT MAY AFFECT THE BURIED (UNDER GROUND) EXISTING SERVICES/UTILITIES SUCH AS ELECTRICAL CABLES, FIBRE OPTIC CABLES, TELECOM CABLES, WATER PIPES. .THIS IS IMPORTANT TO PREVENT ANY DAMAGE TO SUCH SERVICES /UTILITIES SAFETY THREAT TO ALL STATEHOLDERS.

15. NOTES FOR WATERPROOFING WORKS:

- ALL INTERNAL OR EXTERNAL SURFACES OF WATER RETAINING STRUCTURE OR WET AREAS SUCH AS TOILETS, RC ROOF SLABS, RC GUTTERS, M&E ROOMS AND KITCHENS SHALL BE WATERPROOFED WITH APPROVED WATERPROOFING SYSTEM.
 ALL WATERPROOFING WORKS SHALL BE CARRIED OUT BY MANUFACTURER'S APPROVED
- INSTALLER/APPLICATOR AND SHALL BE APPLIED. IN STRICT ACCORDANCE TO THE MANUFACTURER'S APPROVED PROCEDURES OR AS PER ENGINEER'S APPROVAL.
- SUFFICIENT CURING TIME SHALL BE ALLOWED BEFORE INSTALLATION OF ANY PROTECTIVE SCREED OR ARCHITECTURAL FINISHES.
- WATERPROOFING SYSTEMS THAT HAS BEEN APPROVED FOR INSTALLATION SHALL CARRY A 10 YEAR WARRANTY PERIOD BY THE MANUFACTURER OR BY THE MANUFACTURER'S REPRESENTATIVES OR BY THE APPROVED LOCAL DISTRIBUTOR/APPLICATOR.

16. GENERAL NOTES FOR ANY STRUCTURAL STEEL WORKS

- MAIN CONTRACTOR SHALL SUBMIT SHOP DRAWINGS FOR ALL STEEL WORKS FOR STRUCTURAL ENGINEER'S APPROVAL BEFORE ORDERING, PURCHASING, FABRICATING AND ERECTING ANY STEEL STRUCTURAL WORKS
- PROPOSED CONNECTION DETAILS TO BE PROVIDED IN THE STRUCTURAL SHOP DRAWINGS FOR STRUCTURAL ENGINEER'S APPROVAL.
- ALL STEEL SECTION MEMBERS SHALL BE SAND BLASTED BEFORE APPLYING ANY APPROVED ANTI-CORROSION COATING SYSTEM.
- 4. ALL WELDING WORKS SHALL BE CARRIED OUT BY QUALIFIED LICENSED WELDERS.

17. NOTES FOR TURFING

- ALL TURFS SHALL BE 225MM SQUARE FROM AN APPROVED SOURCE FREE FROM LALLANG AND
- BLACK EARTH OF 50MM THICKNESS SHALL BE SPREAD ON TO THE GROUND WHERE TURFING IS
- SPOT TURFING SHALL BE LAID AT 300MM CENTRES.
- CLOSED TURFING TO BANKS SHALL BE PEGGED IN PLACE WITH 25MM DIAMETER PEGS 225MM LONG. ALL TURFING SHALL BE WATERED UNTIL SATISFACTORILY ESTABLISHED AND ALL TURFING THAT HAS BECOME DEFECTIVE WITHIN SIX MONTHS SHALL BE REPLACED AT THE CONTRACTOR'S EXPENSE
- DURING THE PERIOD OF THE WORKS AND MAINTENANCE, THE CONTRACTOR SHALL KEEP ALL TURFED AREAS WATERED, MOWN OR CUT AND CLEARED OF GRASS CUTTING TO THE SATISFACTION OF THE ENGINEER. THE FIRST CUT SHALL BE MADE WHEN THE GRASS IS 100MM HIGH, FOLLOWED BY REGULAR CUTTING SO THAT THE VEGETATION AT NO TIME EXCEEDS 150MM IN HEIGHT.

18. DRAWING NOTE:

ALL STRUCTURAL DRAWING ARE DRAWN TO APPROXIMATE SCALE. ANY DISCREPANCY IN STRUCTURAL DRAWING DIMENSIONS, EXACT DIMENSION SHALL BE REFERRED TO STRUCTURAL ENGINEER

19. GENERAL NOTES FOR FLOOR HARDENER REQUIREMENTS:

ALL CONCRETE SLAB SURFACES WHICH ARE NOT COVERED WITH HEAVY DUTY DECORATIVE TILES AND TO BE USED AS CAR PARKS OR ACCESS ROADS (FOR SELECTED AREAS) SHALL BE APPLIED WITH SUITABLE FLOOR HARDENERS SYSTEM (TO INCLUDE POWER FLOAT TROWELLING IF APPLICABLE)

20. GENERAL NOTES FOR BRICKWALL WORKS:

- ALL BRICKS TO BE USED SHALL BE REGULAR IN SIZE AND APPROVED BY ABCI REINFORCED CONCRETE STIFFENERS (100x100 WITH APPROPRIATE REINFORCEMENTS)SHALL BE PROVIDED AT EVERY INTERVAL OF 3.5m OF BRICK WORK LENGTH

21. NOTES FOR WORKPLACE SAFETY, HEALTH AND ENVIRONMENT COMPLIANCE & INSURANCES & TEMPORARY WORKS:

- MAIN CONTRACTOR SHALL ENSURE TO COMPLY FULLY WITH ALL PREVAILING RULES, REGULATIONS AND LAWS OF NEGARA BRUNEI DARUSSALAM ON WORKPLACE SAFETY, HEALTH AND ENVIRONMENTAL ASPECTS THROUGHOUT THE DURATION OF THE CONSTRUCTION PERIOD AND DEFECTS LIABILITY PERIOD
 2. MAIN CONTRACTOR SHALL ENSURE THAT ALL APPLICABLE INSURANCES ARE VALID THROUGHOUT THE
- CONSTRUCTION PERIOD AND DEFECTS LIABILITY PERIOD SUCH AS CONTRACTOR'S ALL RISK INSURANCE OR OTHERS SUCH AS WORKMEN COMPENSATION INSURANCE POLICY, PUBLIC LIABILITY INSURANCE POLICY AND FIRE INSURANCE POLICY(WHICHEVER IS APPLICABLE AS PER SUPERINTENDING OFFICERS
- 3. MAIN CONTRACTOR SHALL EMPLOY INDEPENDENT CONSULTANT TO CARRYOUT DESIGN WORKS FOR ALL TEMPORARY WORKS AND THAT SUCH TEMPORARY WORKS DESIGN REQUIREMENT ARE FULLY COMPLIED

22. NOTES FOR ROOF TRUSSES:

- ROOF TRUSSES SHALL BE LIGHTWEIGHT PROPRIETARY SYSTEM SUCH AS LYSAGTH SMART TRUSS SYSTEM OR APPROVED TECHNICAL EQUIVALENT SHALL BE DESIGNED BY MANUFACTURER COMPAN
- 2. THE INSTALLATION WORKS SHALL BE CARRIED OUT BY MANUFACTURER'S APPROVED INSTALLER






SERI BUMI CONSULTANT


TEL: 673-2427275 FAX: 673-2427279 E-MAIL: sbc.brunei@gmail.com


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				CHECKED BY	MD. YUNUS	/ h	10	
NO.	AMENDMENTS	BY	DATE	APPROVED BY		رخل	DATE 13/09/2022	

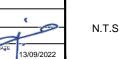

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GENERAL NOTES	SHEET NO:	
PROJECT:	DRAWING NO:	REV:
PROPOSED NEW 1 UNIT STANDARD DESIGN OF FARM LABOUR QUARTERS, BRUNEI DARUSSALAM (FOR 2 PERSONS)	SBC/Q366/AFLQ/2P/RC/G - 100	



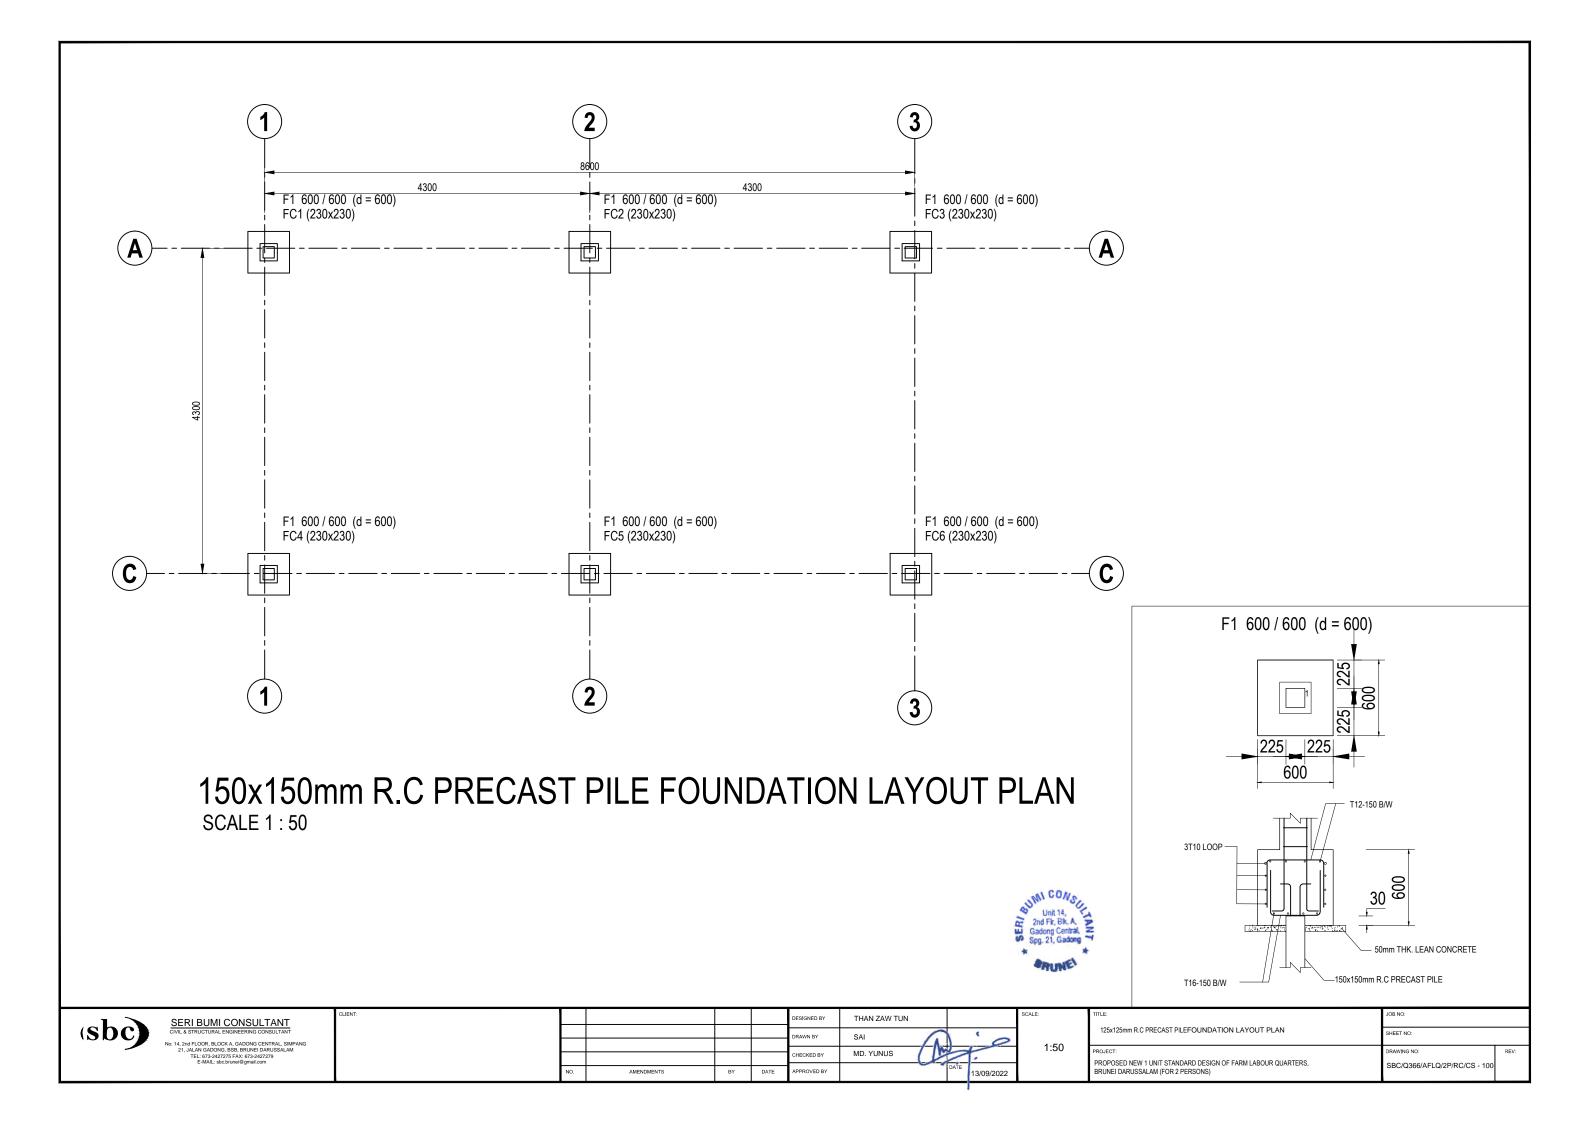

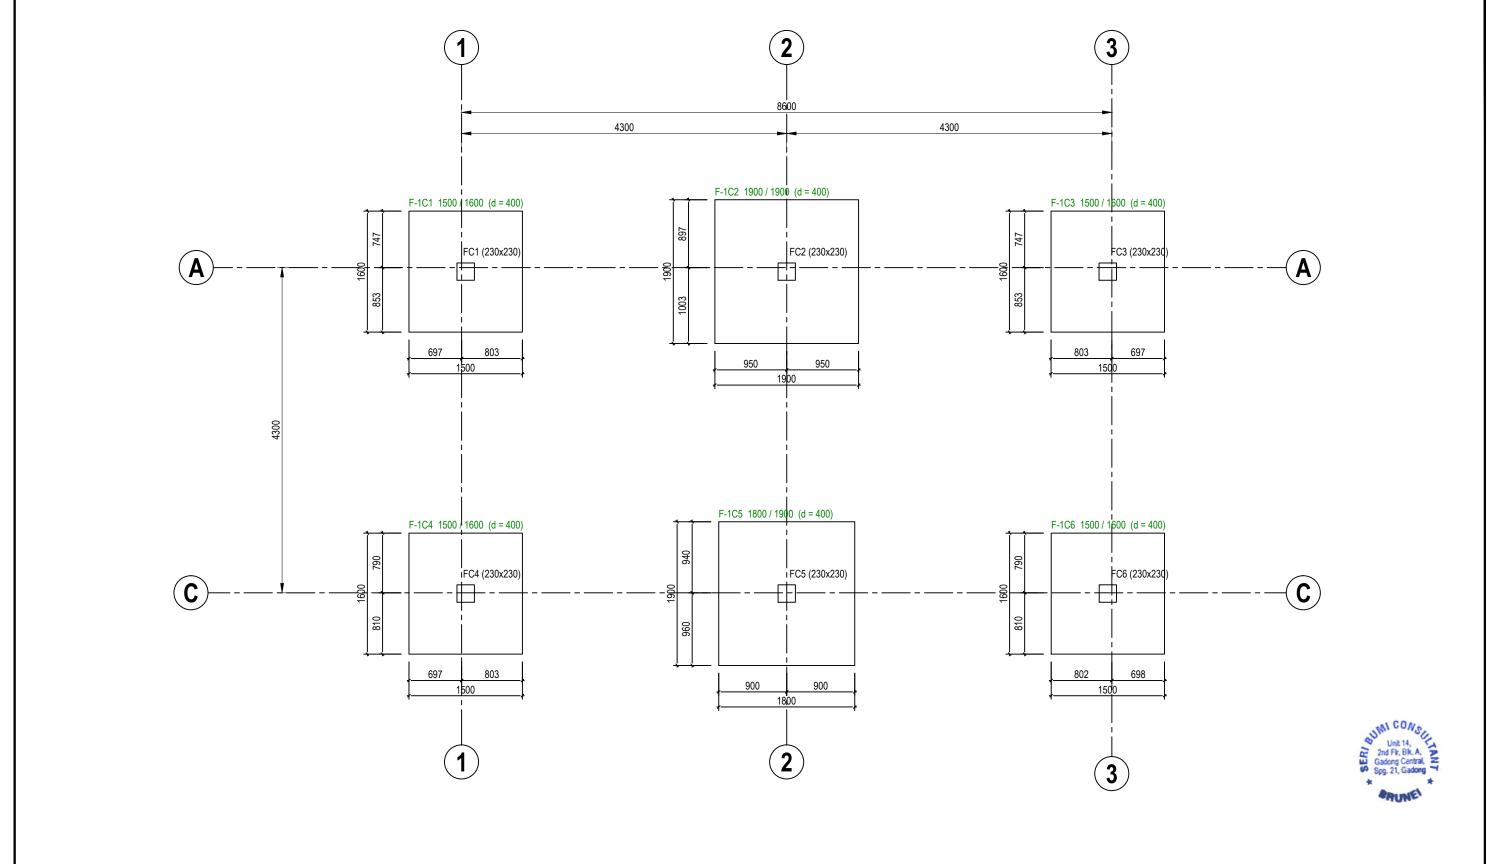PAD FOOTING FOUNDATION LAYOUT PLAN [ALLOWABLE STRESS OF SOIL 100 KN/m²] SCALE 1:50


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CIVIL & STRUCTURAL ENGINEERING CONSULTANT
No: 14, 2nd FLOOR, BLOCKA, CADONG CENTERAL, SMPANG
21, JALAN GADONG ESTRUCT, AGADONG CENTERAL, SMPANG
21, JALAN GADONG CENTERAL, SMPANG
E-MAIL: BACHURBE DARUS SALAM
NO. AMENDMENTS BY DATE APPROVED BY


DESIGNED BY THAN ZAW TUN
DESIGNED BY THAN ZAW TUN
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TITLE:
PAD FOOTING FOUNDATION LAYOUT PLAN
[ALLOWABLE STRESS OF SOIL 100KN/m²]

SHEET NO:
PROJECT:
PROPOSED NEW 1 UNIT STANDARD DESIGN OF FARM LABOUR QUARTERS,
BDC/Q366/AFLQ/2P/RC/CS - 101

SBC/Q366/AFLQ/2P/RC/CS - 101




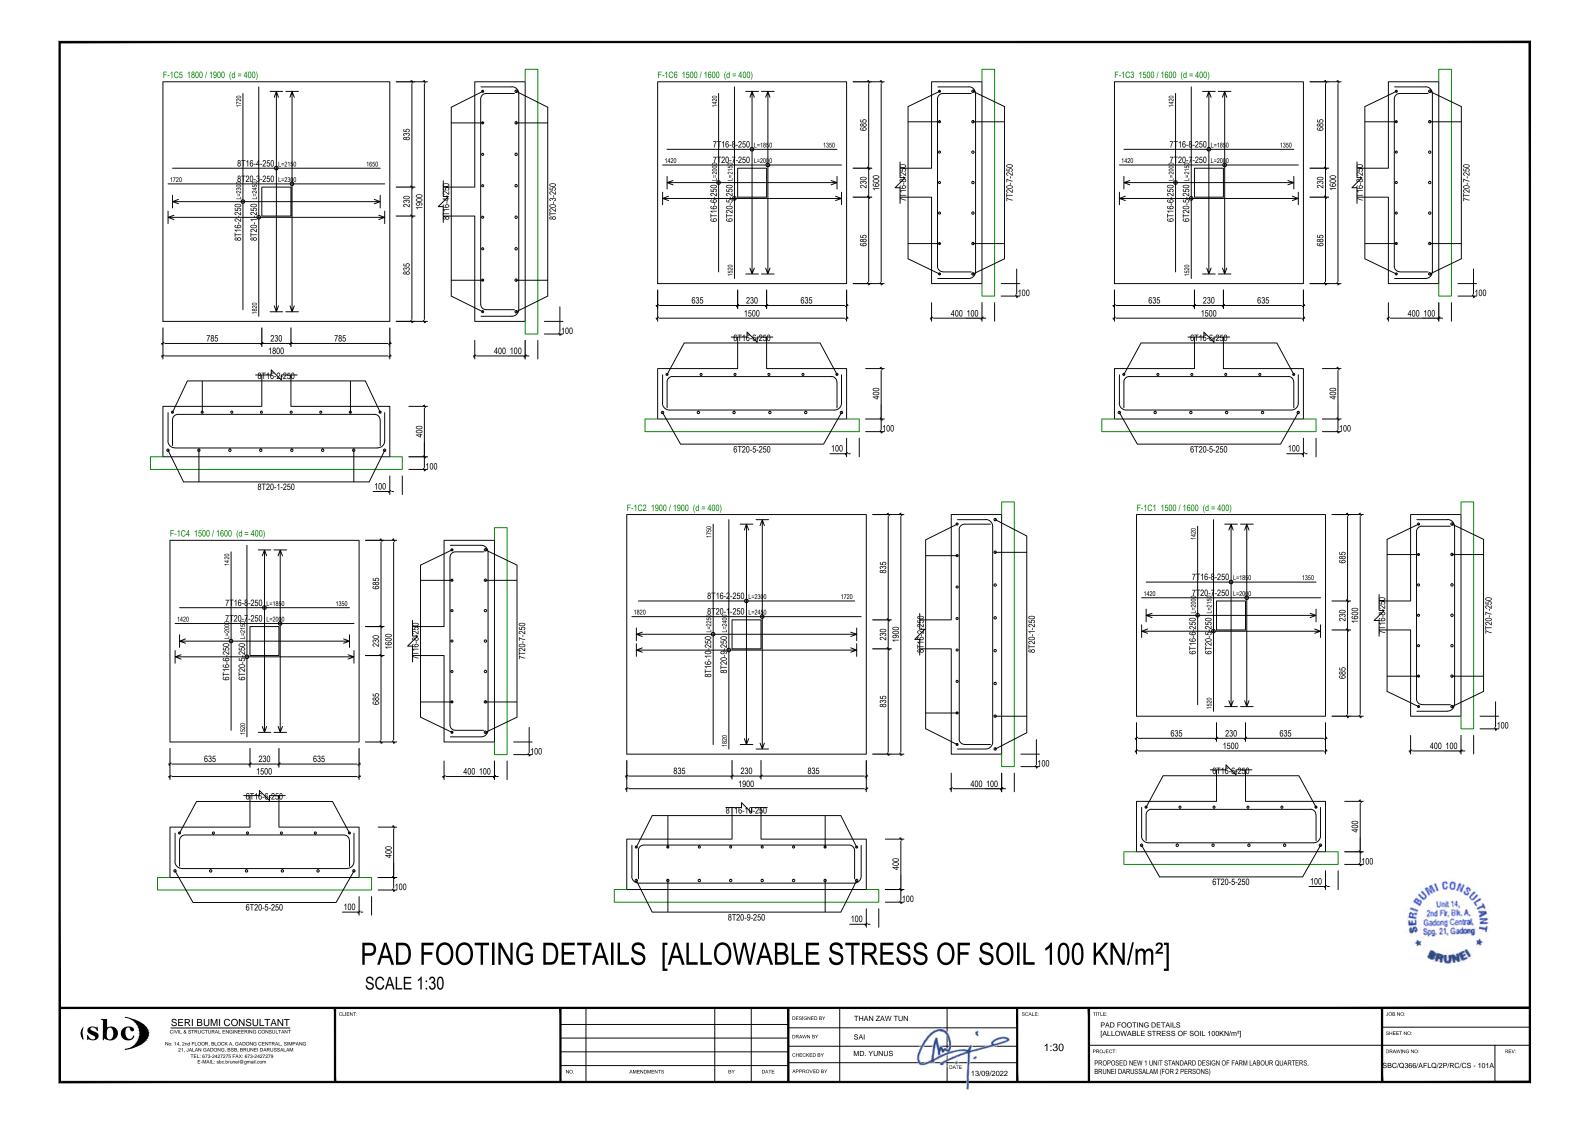

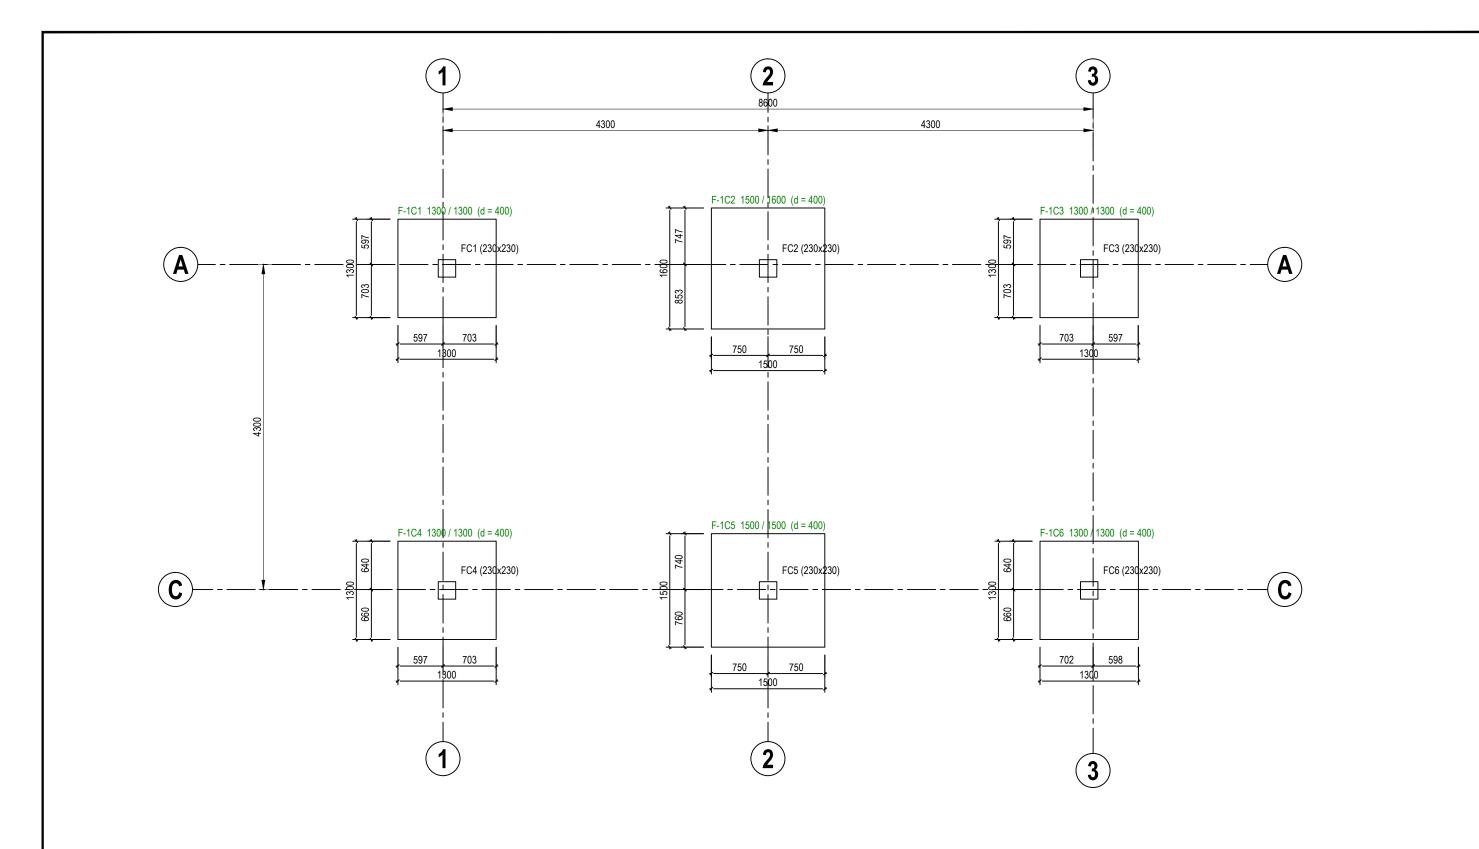
PAD FOOTING FOUNDATION LAYOUT PLAN [ALLOWABLE STRESS OF SOIL 150 KN/m²]

SCALE 1:50

SERI BUMI CONSULTANT	CLIENT:				DESIGNED BY	THAN ZAW TUN	SC.	CALE:	TITLE: PAD FOOTING FOUNDATION LAYOUT PLAN	JOB NO:	
(SDC) CIVIL & STRUCTURAL ENGINEERING CONSULTANT No. 14. 2nd FLOOR, BLOCK A, GADONG CENTRAL, SIMPANG					DRAWN BY	SAI	0	1:50	[ALLOWABLE STRESS OF SOIL 150KN/m²]	SHEET NO:	
21, JALAN GADONG, BSB, BRUNEI DARUSSALAM TEL: 672-2427275 FAX: 673-2427279 E-MAIL: sbt-punei@gmail.com					CHECKED BY	MD. YUNUS		1.50	PROJECT: PROPOSED NEW 1 UNIT STANDARD DESIGN OF FARM LABOUR QUARTERS,	DRAWING NO:	REV:
·		NO. AMENDMENTS	BY	DATE	APPROVED BY	DATE 13/0	/09/2022		BRUNEI DARUSSALAM (FOR 2 PERSONS)	SBC/Q366/AFLQ/2P/RC/CS - 102	

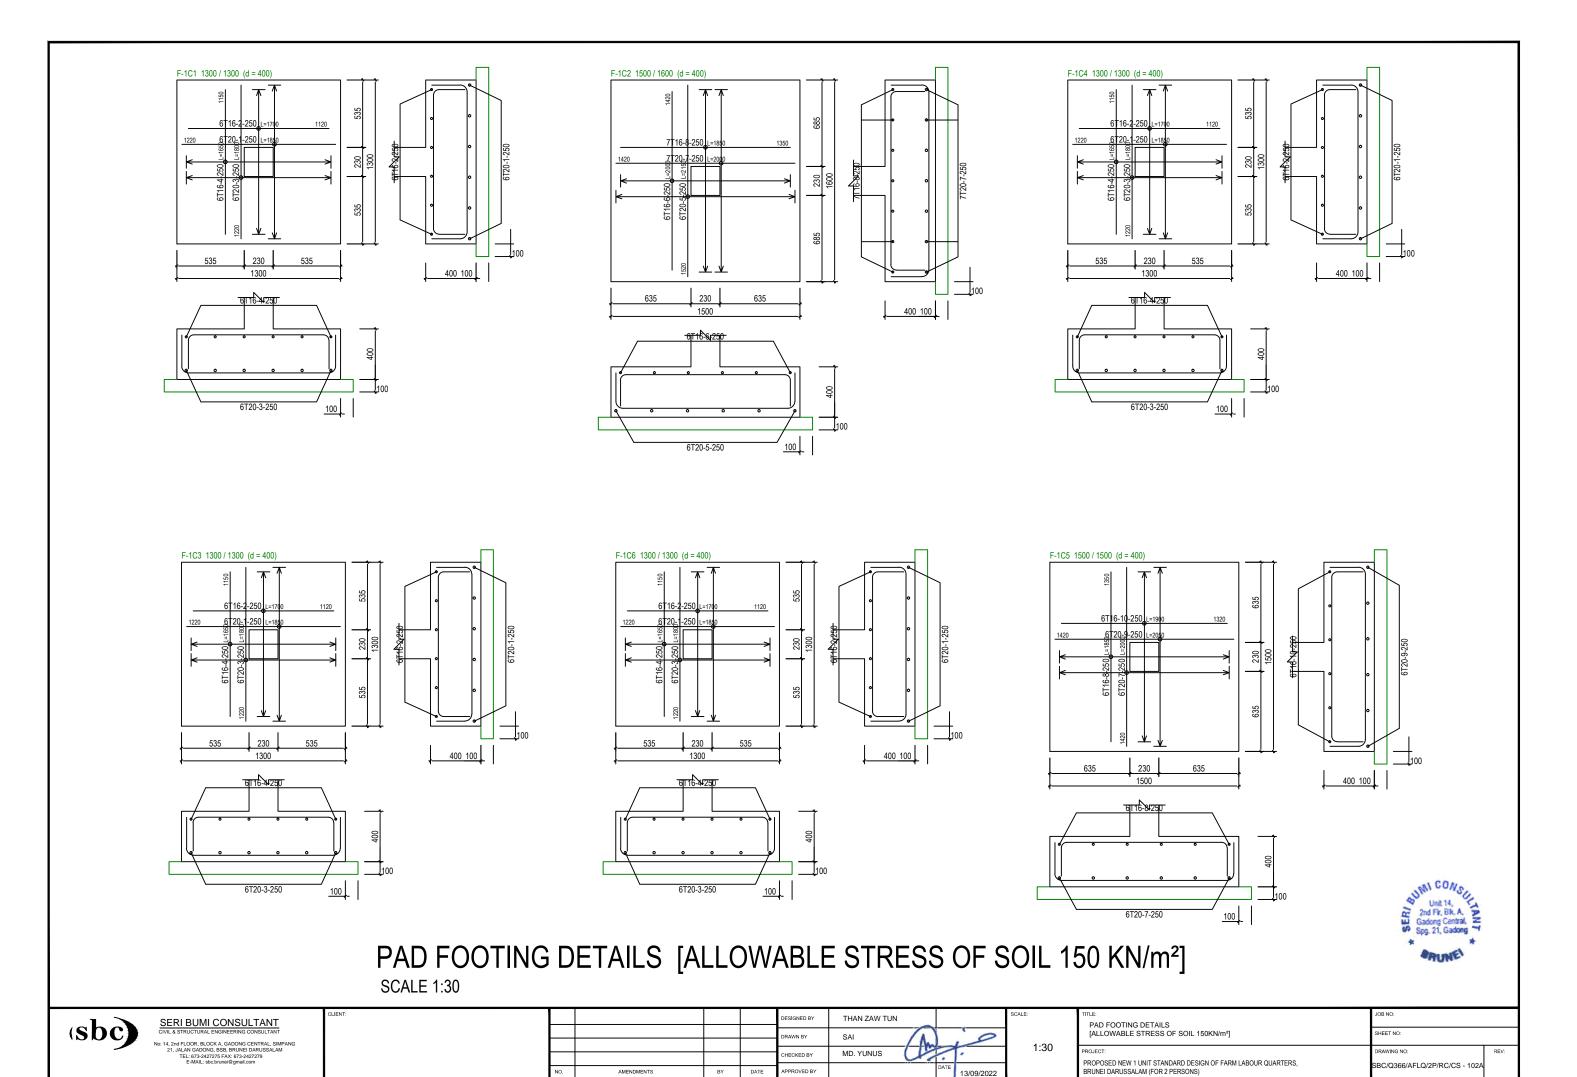

13/09/2022

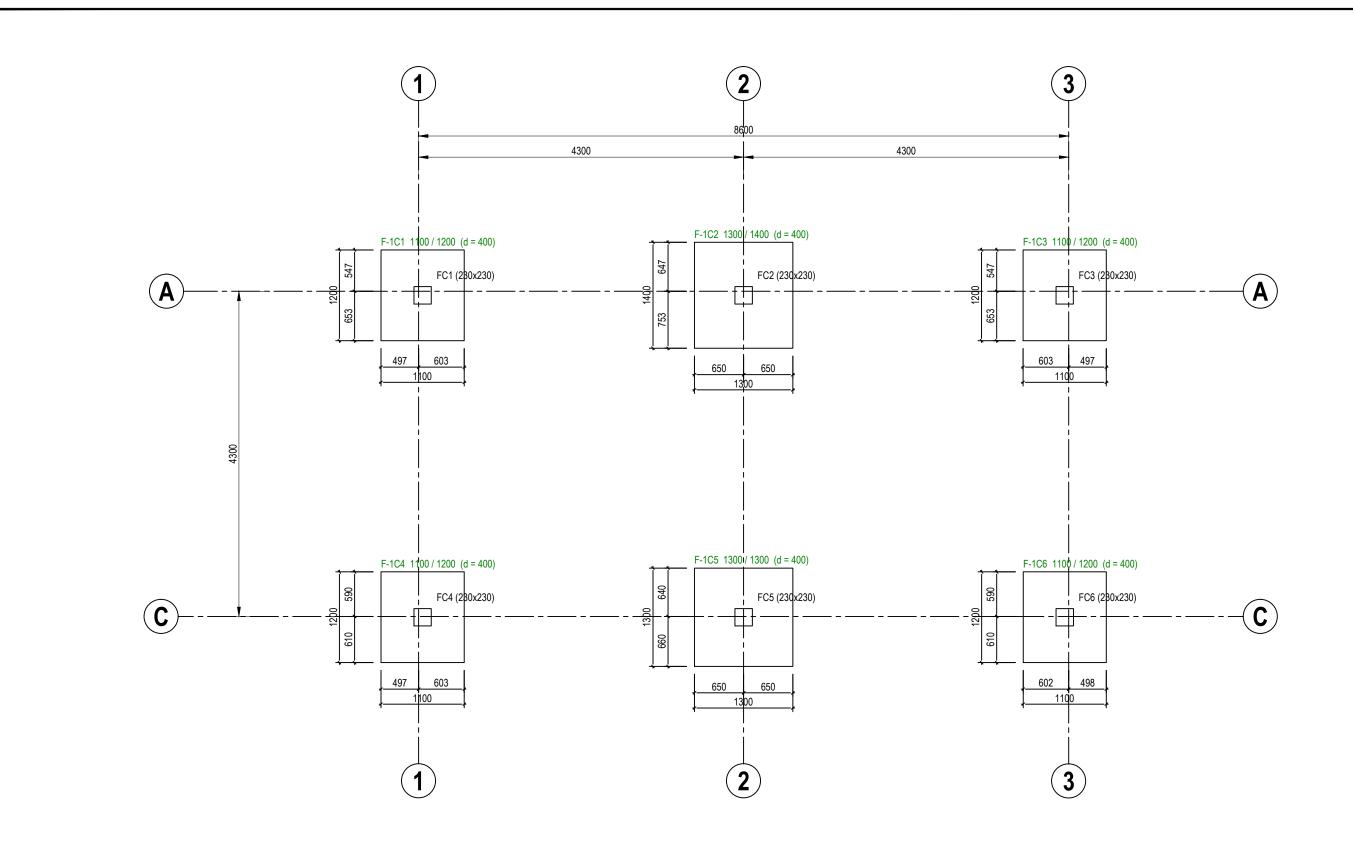


PAD FOOTING FOUNDATION LAYOUT PLAN [ALLOWABLE STRESS OF SOIL 200 KN/m²]



SCALE 1:50

al S	SERI BUMI CONSULTANT	CLIENT:					DESIGNED BY	THAN ZAW TUN			SCALE:	TITLE: PAD FOOTING FOUNDATION LAYOUT PLAN	JOB NO:	
(SDC)	CIVIL & STRUCTURAL ENGINEERING CONSULTANT No: 14, 2nd FLOOR, BLOCK A, GADONG CENTRAL, SIMPANG						DRAWN BY	SAI	١.	0	4.50		SHEET NO:	
	21, JALAN GÁDONG, BSB, BRUNEI DARUSSÁLAM TEL: 673-2427275 FAX: 673-2427279 E-MÁIL: sbc.bruneil@gmail.com						CHECKED BY	MD. YUNUS	7		1:50		DRAWING NO:	REV:
	-		NO.	AMENDMENTS	BY	DATE	APPROVED BY		DATE 1	3/09/2022		BRUNEI DARUSSALAM (FOR 2 PERSONS)	SBC/Q366/AFLQ/2P/RC/CS - 103	3

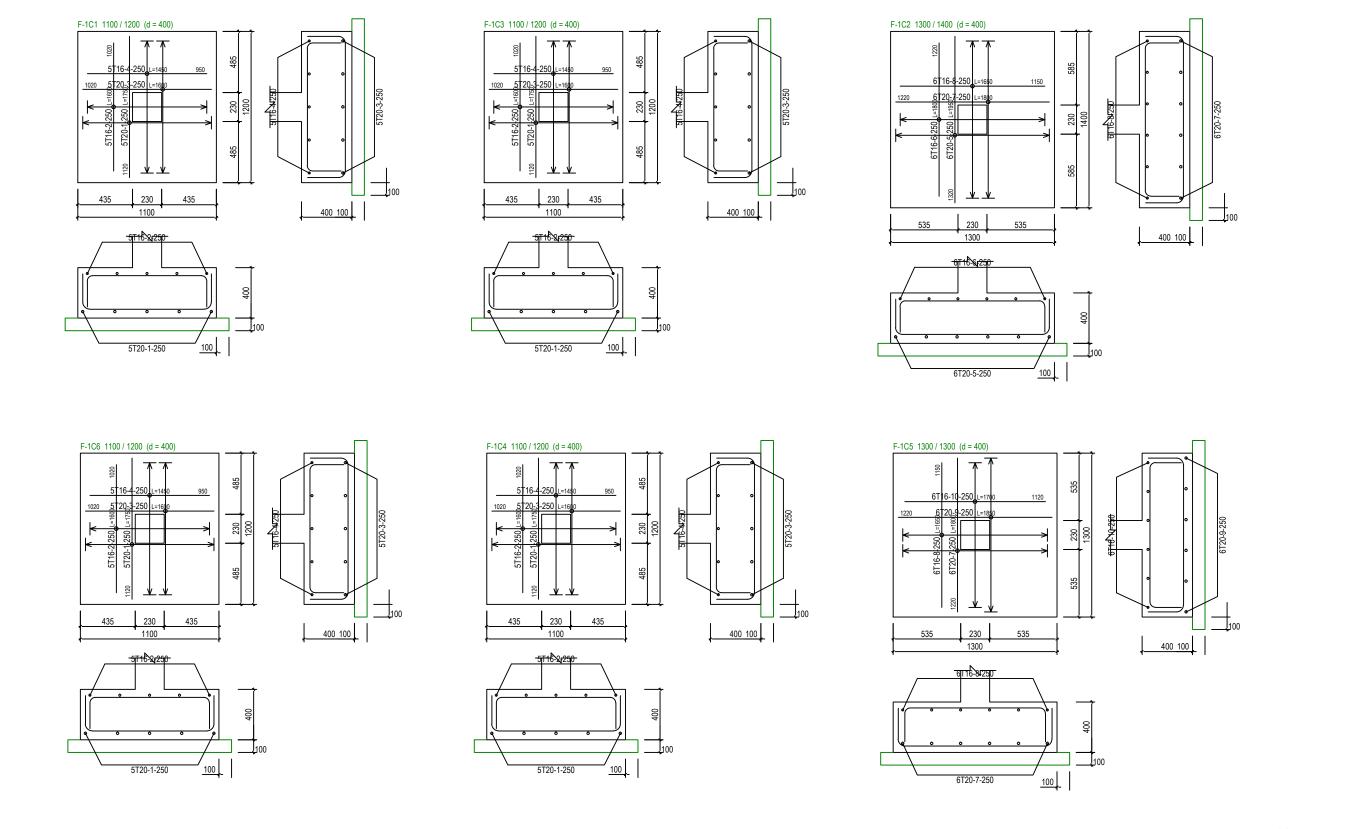

PAD FOOTING DETAILS [ALLOWABLE STRESS OF SOIL 200 KN/m²] SCALE 1:30




1.	SERI BUMI CONSULTANT	CLIENT:					DESIGNED BY	THAN ZAW TUN		SCALE:	TITLE: PAD FOOTING DETAILS	JOB NO:	
(Sbc)	CIVIL & STRUCTURAL ENGINEERING CONSULTANT No: 14, 2nd FLOOR, BLOCK A, GADONG CENTRAL, SIMPANG						DRAWN BY	SAI	1 ' 0		[ALLOWABLE STRESS OF SOIL 200KN/m²]	SHEET NO:	
	21, JALAN GADONG, BSB, BRUNEI DARUSSALAM TEL: 673-2427275 FAX: 673-2427279 E-MAIL: sbc.brunei@gmail.com						CHECKED BY	MD. YUNUS		1:30	PROJECT: PROPOSED NEW 1 UNIT STANDARD DESIGN OF FARM LABOUR QUARTERS.	DRAWING NO: REV	≣V:
			NO.	AMENDMENTS	BY	DATE	APPROVED BY		13/09/2022		BRUNEI DARUSSALAM (FOR 2 PERSONS)	SBC/Q366/AFLQ/2P/RC/CS - 103A	

St: 2 (+4.00m)	A-1	A-2	A-3	C-1	C-2	C-3
St: 1 (+1.00m)	1 A 62 62 168 230 (230x230) 4T12 Link:T10-125	AS BELOW	3 A 62 8 8 8 (230x230) 4T12 Link:T10-125	C 1 168 230 (230x230) 4T12 Link:T10-125	AS BELOW	C 1663 230 (230x230) 4T12 Link:T10-125
	A 62 62 8 8 8 8 8 8 8 8 8 8 8 8 8 8 8 8 8	2 A 62 8 8 115 115 230 (230x230) 4T12 Link:T10-125	3 A 62 8 8 1682 230 (230x230) 4T16 Link:T10-175	C 1 168 230 (230x230) 4T16 Link:T10-175	2 C 115 115 230 (230x230) 4T12 Link:T10-125	C 1663 230 (230x230) 4T16 Link:T10-175
	1C1,2C1	1C2,2C2	1C3,2C3	1C4,2C4	1C5,2C5	1C6,2C6



SERI BUMI CONSULTANT	CLIENT:					DESIGNED BY	THAN ZAW TUN		SCALE:	TITLE:	JOB NO:	
(SDC) CIVIL & STRUCTURAL ENGINEERING CONSULTANT No. 14, 2nd FLOOR, BLOCK A, GADONG CENTRAL, SIMPANG						DRAWN BY	SAI	.0		COLUMN SCHEDULE	SHEET NO:	
21, JALAN GÁDONG, BSB, BRUNEI DARUSSALAM TEL: 673-2427275 FAX: 673-2427279 E-MAIL: sbc.brunei@gmail.com						CHECKED BY	MD. YUNUS		14.1.0	PROJECT: PROPOSED NEW 1 UNIT STANDARD DESIGN OF FARM LABOUR QUARTERS,	DRAWING NO:	REV:
·		NO.	AMENDMENTS	BY	DATE	APPROVED BY	, , , , , , , , , , , , , , , , , , , 	13/09/2022		BRUNEI DARUSSALAM (FOR 2 PERSONS)	SBC/Q366/AFLQ/2P/RC/CS - 104	+

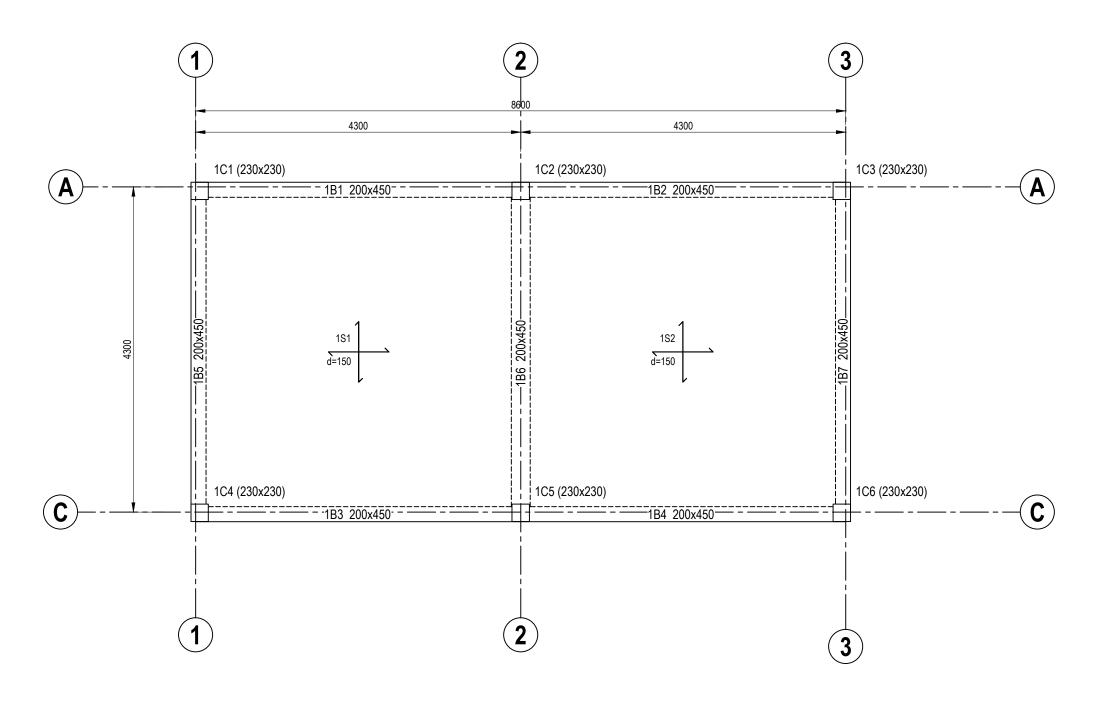


GROUND FLOOR BEAM LAYOUT PLAN

SCALE 1:50




SERI BUMI CONSULTANT	CLIENT:					DESIGNED BY	THAN ZAW TUN			SCALE:	TITLE:	JOB NO:	
(SOC) CIVIL & STRUCTURAL ENGINEERING CONSULTANT No: 14, 2nd FLOOR, BLOCK A, GADONG CENTRAL, SIMPANG						DRAWN BY	SAI		0		GROUND FLOOR BEAM LAYOUT PLAN	SHEET NO:	
NO: 14, 201 FLOUR, BLOCK A, GADUNG ECHT FAL, SIMP ² ANS 21, JALAN GADONG, BSB, BRUNEI DARUSSALAM TEL: 673-2427275 FAX: 673-2427279 E-MAIL: sbc.brunei ggmail.com						CHECKED BY	MD. YUNUS		•		PROJECT:	DRAWING NO:	REV:
L-MAIL. SOLUTION (SITTAL)		NO.	AMENDMENTS	BY	DATE	APPROVED BY		DATE	13/09/2022		PROPOSED NEW 1 UNIT STANDARD DESIGN OF FARM LABOUR QUARTERS, BRUNEI DARUSSALAM (FOR 2 PERSONS)	SBC/Q366/AFLQ/2P/RC/CS - 200	

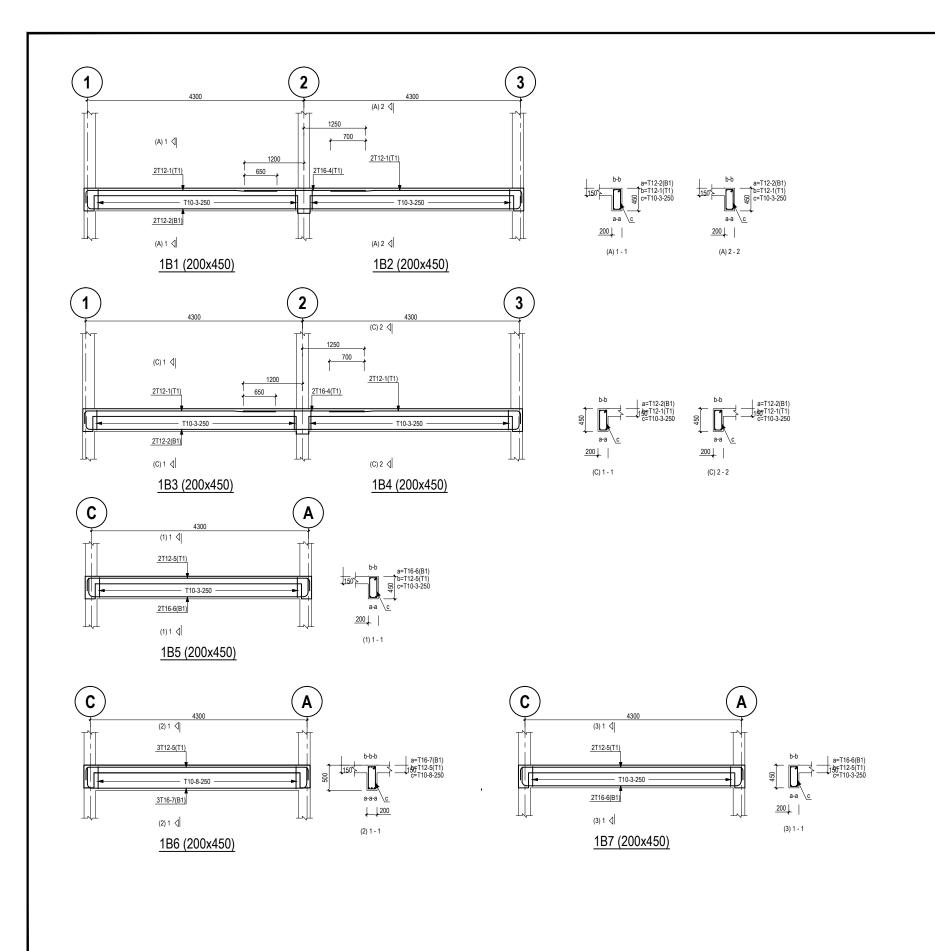



-l-N	SERI BUMI CONSULTANT	CLIENT:					DESIGNED BY	THAN ZAW TUN			SCALE:	TITLE:	JOB NO:	
CIVIL 8 STRUCTURAL ENGINEERING CONSULTANT No: 14, 2nd Fl.Odr. BLOCK A. GADONG CENTRAL, SIMPANG 21, JALAN GADONG, 658, B.R. BRUNE I FARUSSALAM TEL: 673-2427275 FAX: 673-2427279 E-MAIL: 58bctune@gmail.com						DRAWN BY	SAI	× ×	0	N.T.C	GROUND FLOOR BEAM DETAILS	SHEET NO:		
						CHECKED BY	MD. YUNUS	_		N.1.5	PROJECT: PROPOSED NEW 1 UNIT STANDARD DESIGN OF FARM LABOUR QUARTERS,	DRAWING NO:	REV:	
	-		NO.	AMENDMENTS	BY	DATE	APPROVED BY	7.TT	DATE 1	3/09/2022		BRUNEI DARUSSALAM (FOR 2 PERSONS)	SBC/Q366/AFLQ/2P/RC/CS - 201	1

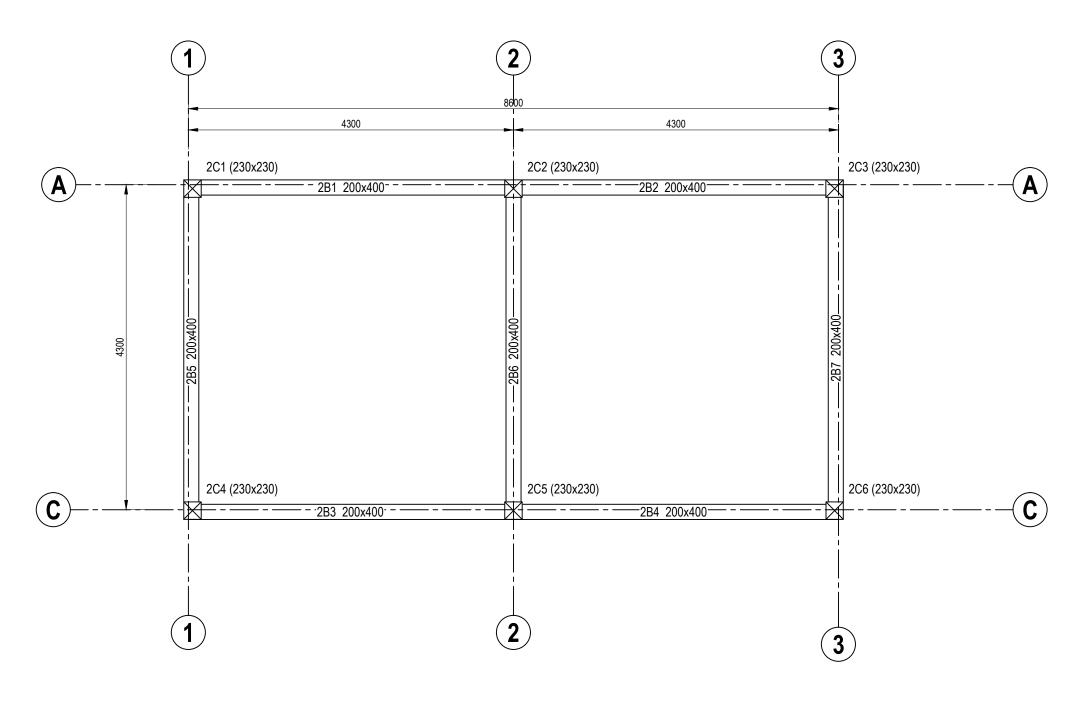


ROOF BEAM LAYOUT PLAN

SCALE 1:50




SERI BUMI CONSULTANT				DESIGNED BY	THAN ZAW TUN		SCALE:	TITLE:	JOB NO:
(SDC) CIVIL & STRUCTURAL ENGINEERING CONSULTANT No. 14, 2nd FLOOR, BLOCK A, GADONG CENTRAL, SIMPANG				DRAWN BY	SAI	.0	1:50	ROOF BEAM LAYOUT PLAN	SHEET NO:
21, JALAN GADONG, BSB, BRUNEI DARUSSALAM TEL: 673-2472775 FAX: 673-2427279 E-MAIL: Sobutumie@gmail.com				CHECKED BY	MD. YUNUS		1.50	PROJECT: PROPOSED NEW 1 UNIT STANDARD DESIGN OF FARM LABOUR QUARTERS,	DRAWING NO: REV
	NO.	AMENDMENTS	BY DATE	APPROVED BY	, , , , , , , , , , , , , , , , , , ,	13/09/2022		BRUNEI DARUSSALAM (FOR 2 PERSONS)	SBC/Q366/AFLQ/2P/RC/CS - 300

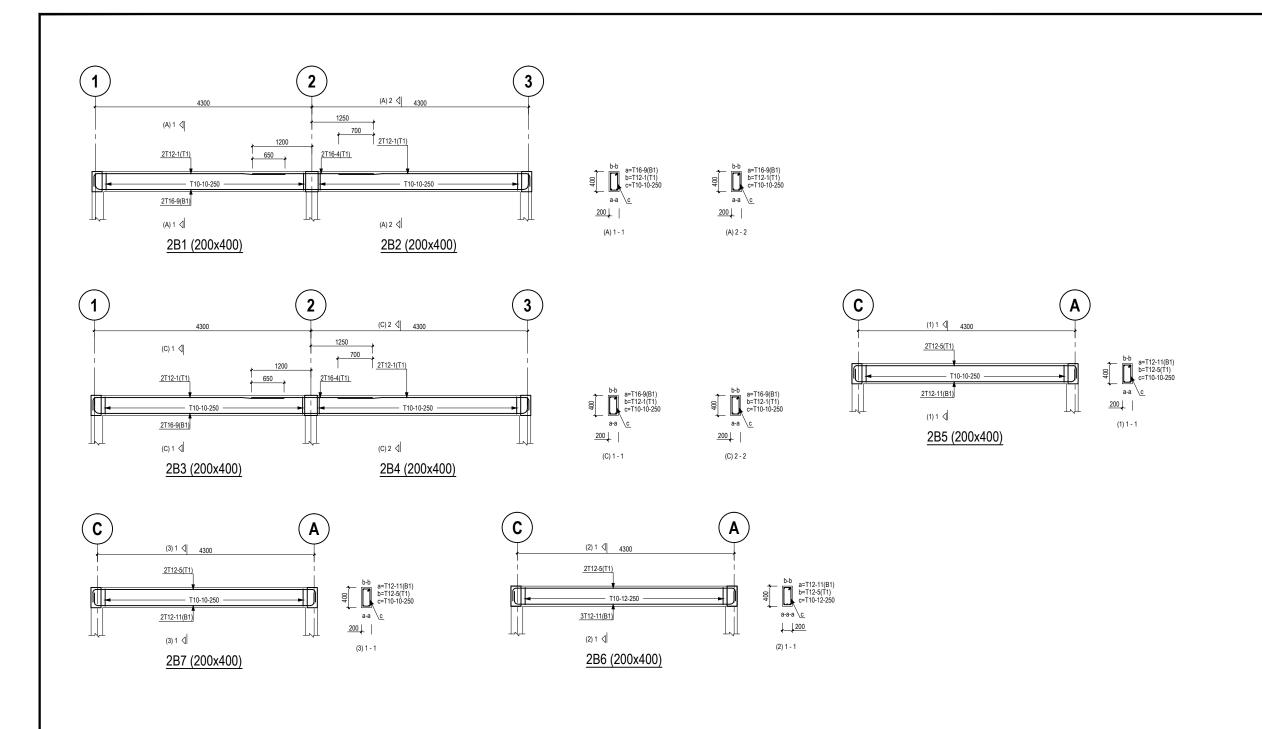



SERI BUMI CONSULTANT	CLIENT:				DESIGNED BY	THAN ZAW TUN		SCALE:	TITLE:	JOB NO:	
CIVIL & STRUCTURAL ENGINEERING CONSULTANT No: 14, 2nd FLOOR, BLOCK A, GADONG CENTRAL, SIMPANG					DRAWN BY	SAI	10] ,,,,,	ROOF BEAM DETAILS	SHEET NO:	
21, JALAN GADONG, BSB, BRUNEI DARUSSALAM TEL: 673-2427275 FAX: 673-2427279 E-MAIL: sbc.brune(gmail.com		CHECKED BY M.D. YUNUS	N.T.S	PROJECT: PROPOSED NEW 1 UNIT STANDARD DESIGN OF FARM LABOUR QUARTERS.	DRAWING NO:	REV:					
		NO. AMENDMENTS	BY	DATE	APPROVED BY		13/09/2022		BRUNEI DARUSSALAM (FOR 2 PERSONS)	SBC/Q366/AFLQ/2P/RC/CS - 301	

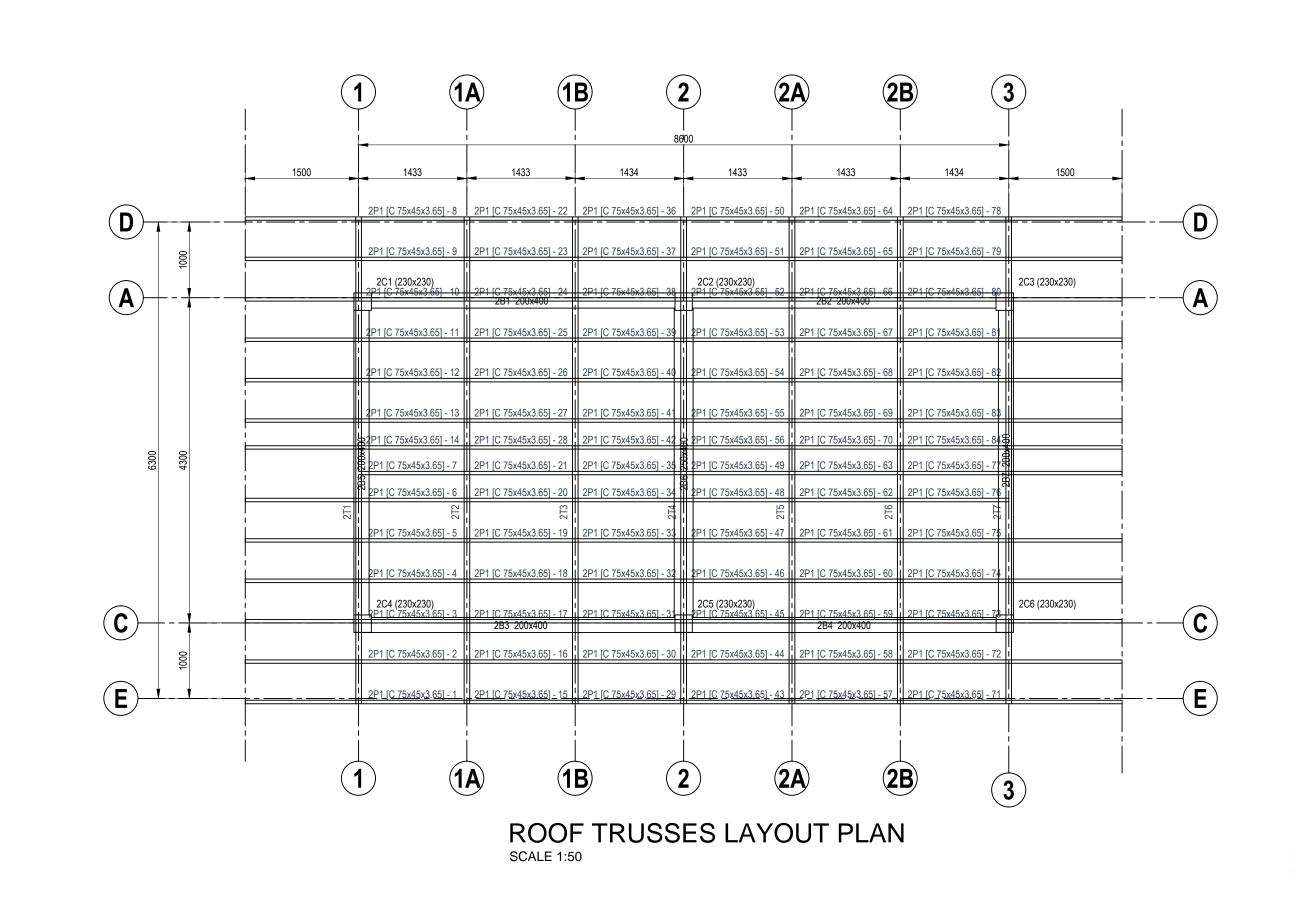






THAN ZAW TUN SERI BUMI CONSULTANT RAWN BY SAI MD. YUNUS HECKED BY AMENDMENTS PROVED BY

N			SCALE:	1
A		,0	1:50	F
	DATE	17/09/2022		
			-	_

TITLE:	
ROOF TRUSSES LAYOUT PLAN	
PROJECT:	
PROPOSED NEW 1 UNIT STANDARD DESIGN OF FARM LABOUR QUARTERS,	

SBC/Q366/AFLQ/2P/RC/CS - 400

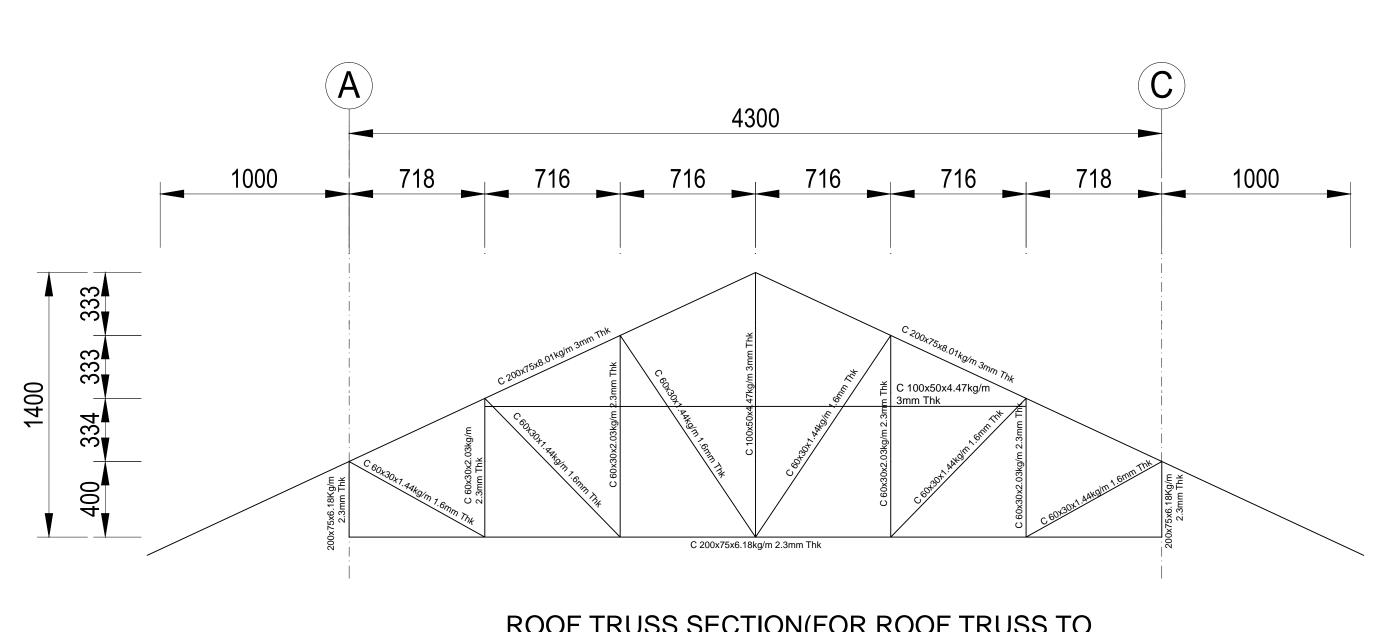



ROOF TRUSS SECTION(FOR ROOF TRUSS TO REINFORCE CONCRETE BEAM CONNECTION)




SERIBUMI CONSULTANT
CIVIL & STRUCTURAL ENDINEERING CONSULTANT
THE LOTS JACK 2775 FAX 07 02 4247275
E-HAIL: enchrowled genal con
No. Amendments By Date Approved by THAN ZAW TUN

DESIGNED BY THAN ZAW TUN
THE LOTS JACK 2775 FAX 07 02 4247275
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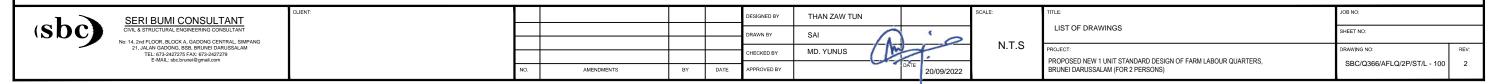


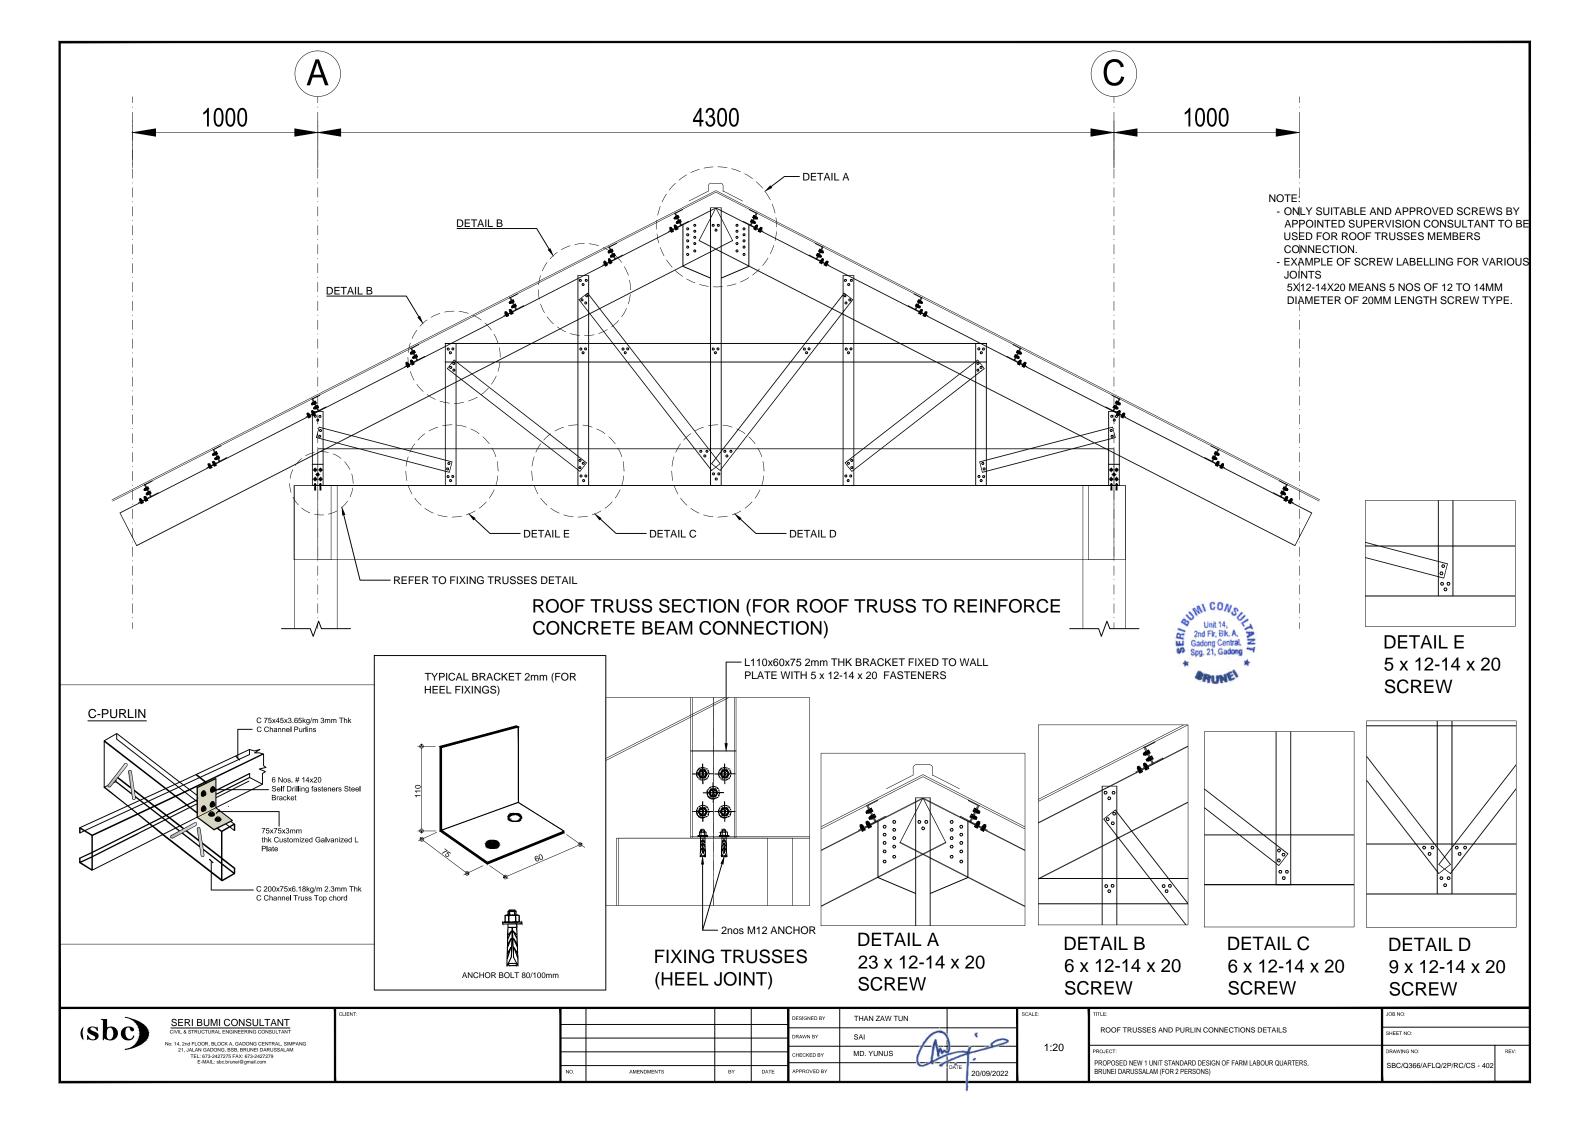

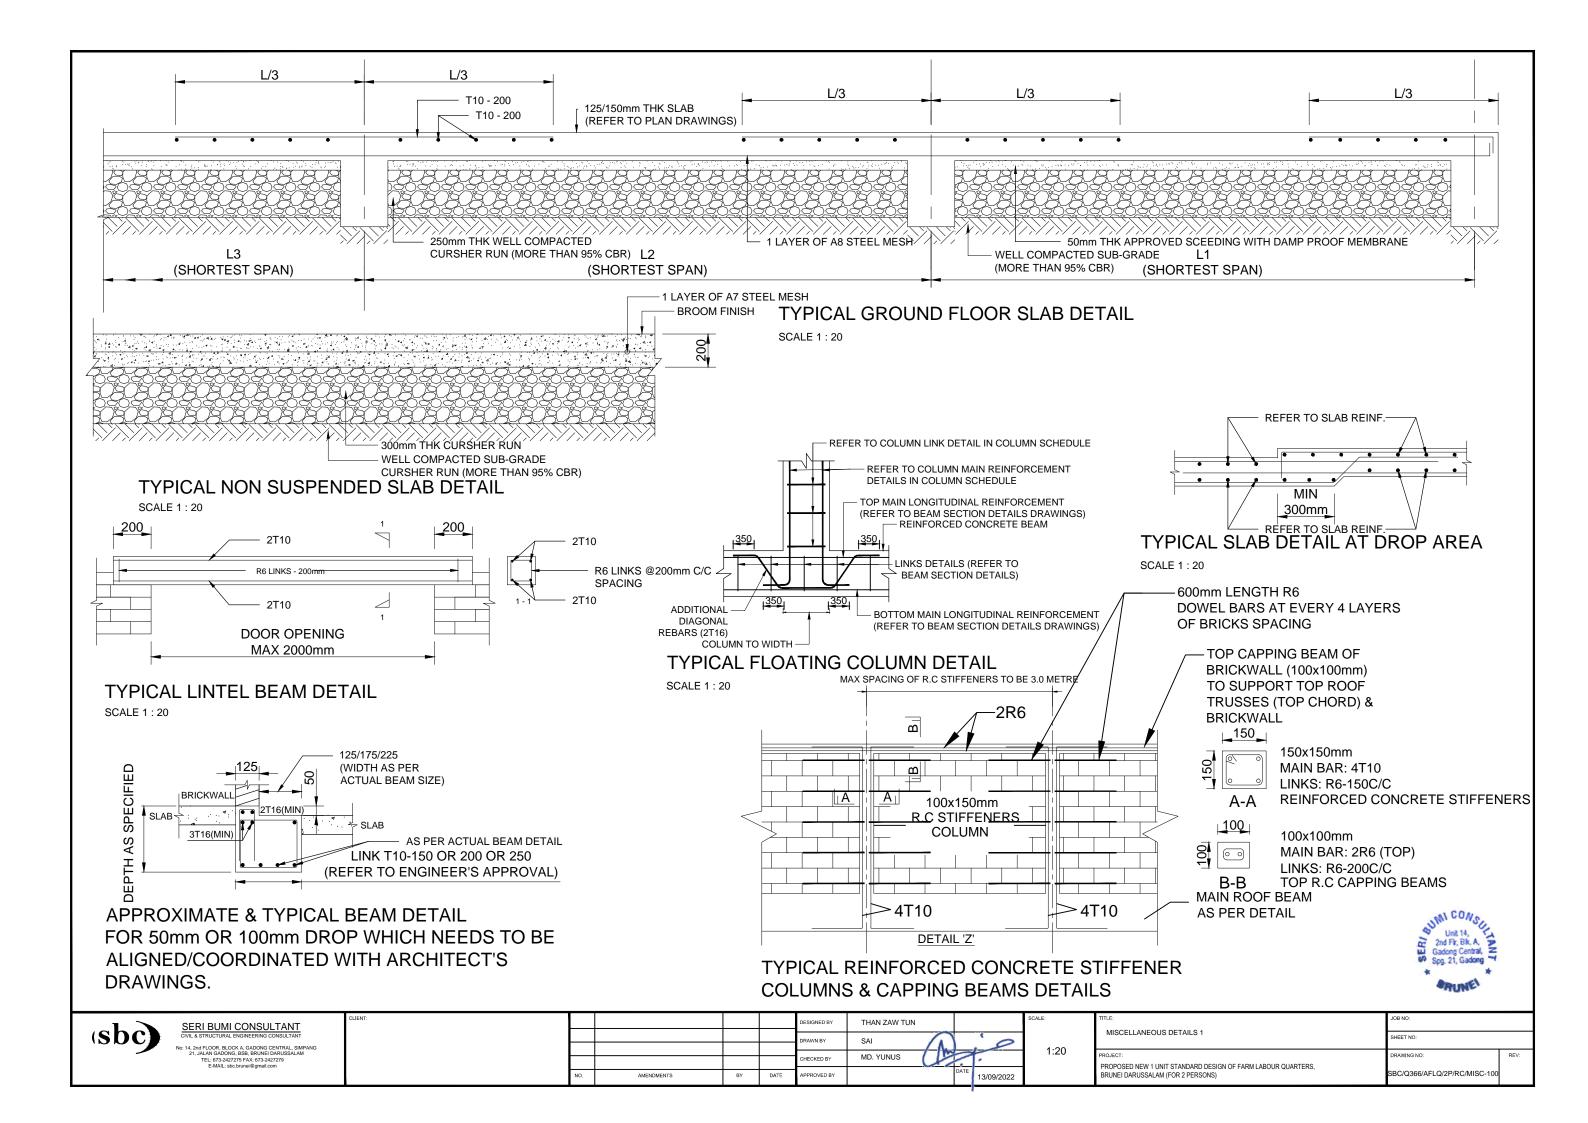PROPOSED NEW 1 UNIT STANDARD DESIGN OF FARM LABOUR QUARTERS, BRUNEI DARUSSALAM (FOR 2 PERSONS)

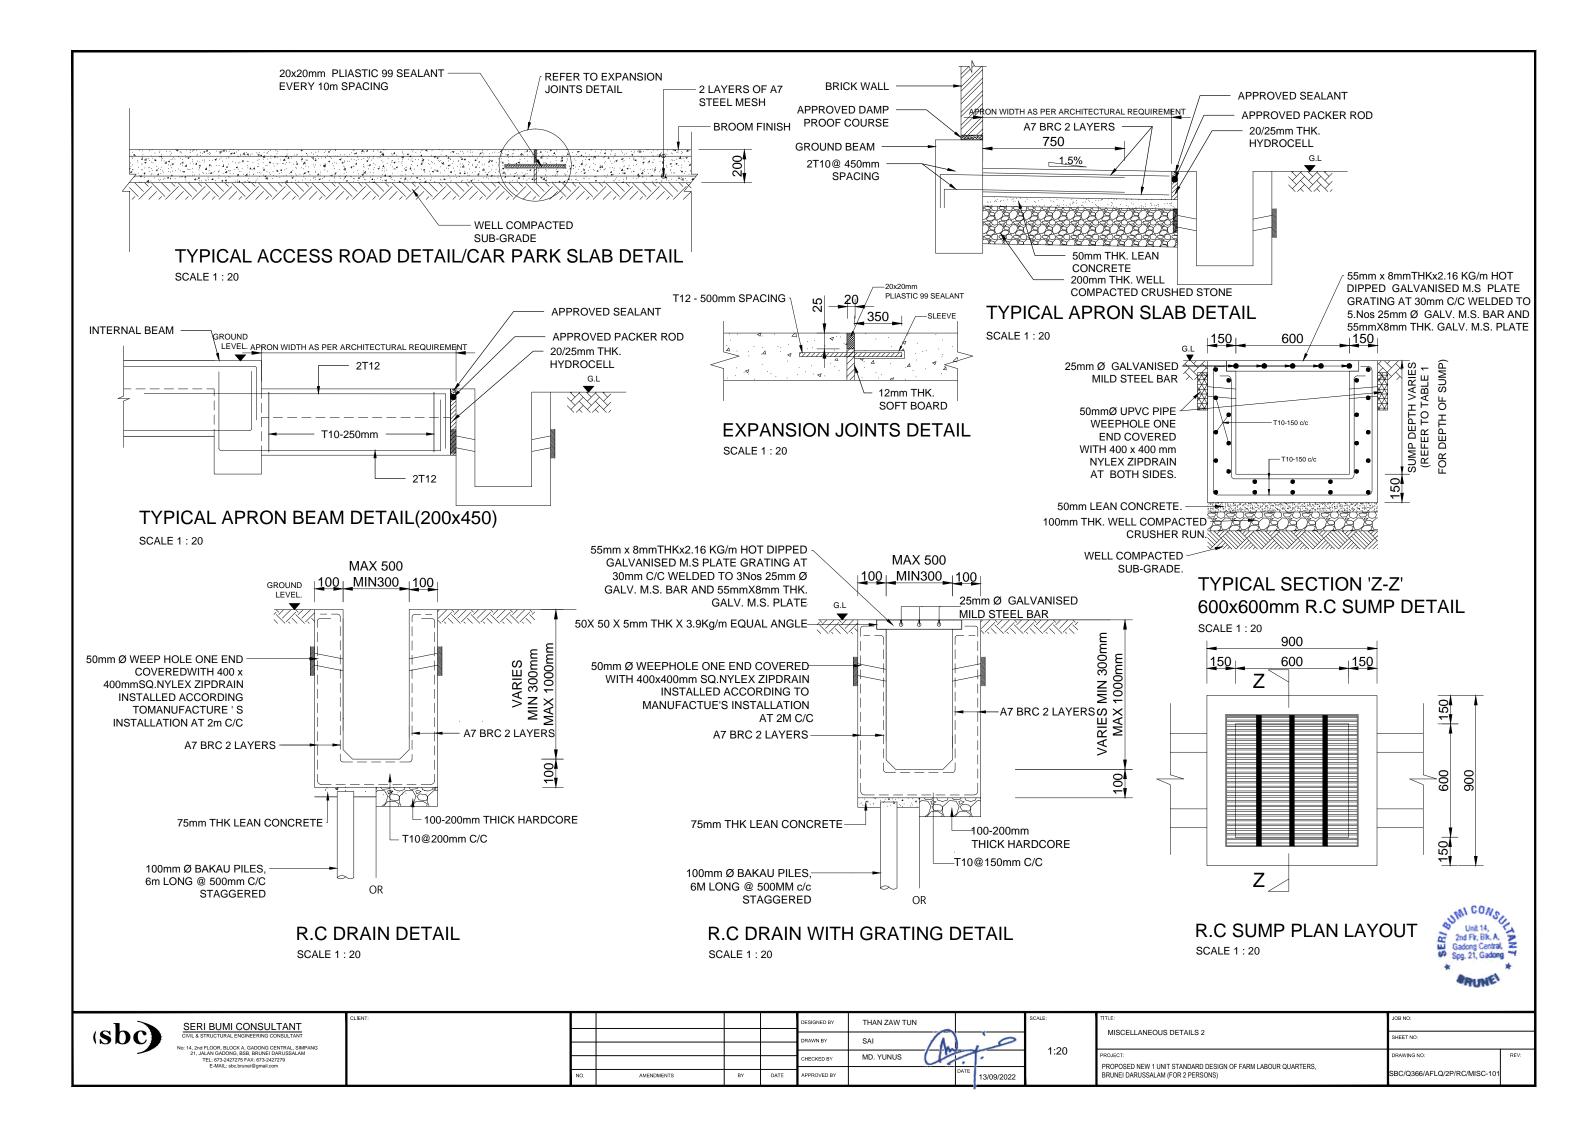	LIST OF DRAWINGS											
	DESCRIPTIONS	DRAWING NO.	REVISION NO.	REMARKS								
$\{$ $\begin{bmatrix} 1 \\ 1 \end{bmatrix}$	LIST OF DRAWINGS	SBC/Q366/AFLQ/2P/ST/L - 100	2									
2	GENERAL NOTES	SBC/Q366/AFLQ/2P/ST/G-100										
3	150x150mm R.C PRECAST PILE FOUNDATION LAYOUT PLAN	SBC/Q366/AFLQ/2P/ST/CS-100										
4	PAD FOOTING FOUNDATION LAYOUT PLAN [ALLOWABLE STRESS OF SOIL 100 kN/m²]	SBC/Q366/AFLQ/2P/ST/CS-101										
5	PAD FOOTING DETAILS [ALLOWABLE STRESS OF SOIL 100 kN/m²]	SBC/Q366/AFLQ/2P/ST/CS-101A										
6	PAD FOOTING FOUNDATION LAYOUT PLAN [ALLOWABLE STRESS OF SOIL 150 kN/m²]	SBC/Q366/AFLQ/2P/ST/CS-102										
7	PAD FOOTING DETAILS [ALLOWABLE STRESS OF SOIL 150 kN/m²]	SBC/Q366/AFLQ/2P/ST/CS-102A										
8	PAD FOOTING FOUNDATION LAYOUT PLAN [ALLOWABLE STRESS OF SOIL 200 kN/m²]	SBC/Q366/AFLQ/2P/ST/CS-103										
9	PAD FOOTING DETAILS [ALLOWABLE STRESS OF SOIL 200 kN/m²]	SBC/Q366/AFLQ/2P/ST/CS-103A										
10	COLUMN SCHEDULE	SBC/Q366/AFLQ/2P/ST/CS-104										
11	GROUND FLOOR BEAM LAYOUT PLAN	SBC/Q366/AFLQ/2P/ST/CS-200										
12	GROUND FLOOR BEAM DETAILS	SBC/Q366/AFLQ/2P/ST/CS-201										
13	ROOF BEAM LAYOUT PLAN	SBC/Q366/AFLQ/2P/ST/CS-300										
14	ROOF TRUSSES LAYOUT PLAN	SBC/Q366/AFLQ/2P/ST/CS-400										
15	ROOF TRUSS SECTION(FOR ROOF TRUSS TO REINFORCE CONCRETE	SBC/Q366/AFLQ/2P/ST/CS-401	}									
16	IDEAM CONNECTION)	SBC/Q366/AFLQ/2P/S1/CS-402	}									
17	MISCELLANEOUS DETAILS - 1	SBC/Q366/AFLQ/2P/ST/MISC-100										
18	MISCELLANEOUS DETAILS - 2	SBC/Q366/AFLQ/2P/ST/MISC-101										





GENERAL

- 1.1 SETTING OUT:
 - ALL DIMENSIONS MEASURED ON SITE SHALL BE CHECKED AND CONFIRMED WITH RELEVANT ARCHITECTURAL, M&E, CIVIL AND STRUCTURAL DRAWINGS.
- 1.2 ANY DISCREPANCIES BETWEEN ARCHITECTURAL, C&S AND M&E DRAWINGS SHALL BE REFERRED TO PROJECT ARCHITECT OR STRUCTURAL ENGINEER OR
- 1.3 PLEASE NOTE THAT THE ARCHITECTURAL DRAWINGS GRID LINE AND STRUCTURAL DRAWINGS GRID LINES HAVE BEEN PURPOSELY OFF-SET TO EASE CONSTRUCTION ON STRUCTURAL MEMBERS.
- 2. STANDARDS & CODE OF PRACTICE
- 2.1 BS 8110 : 1985 STRUCTURAL USE OF CONCRETE
 2.2 PBD 12 : 2008 BUILDING GUIDELINES AND REQUIREMENTS
- 2.3 BS 4449: 1978 HOT ROLLED STEEL BARS FOR THE REINFORCEMENT OF CONCRETE
- 3. CONCRETE
- 3.1 CONCRETE STRENGTH: 25 N/mm² (GRADE 25) UNLESS OTHERWISE
 - STATED LEAN CONCRETE - 15 N/mm² COLUMN - 25 N/mm² 25 N/mm²
- 3.2 CONCRETE COVER TO ALL REINFORCEMENT INCLUDING LINKS SHALL MEET THE 2-HOUR FIRE RATING & AS STATED BELOW (UNLESS OTHERWISE STATED)
 - COLUMNS: 30mm BEAMS PILE CAPS : 75mm
- 3.3 CONCRETE CURING: TO BE CARRIED OUT BY SPRAYING WITH WATER AND COVERING WITH EITHER GUNI SACKS OR PLASTIC
- 3.4 ANY COLD JOINTS AND HACKED CONCRETE SURFACE SHALL BE APPLIED WITH APPROVED BONDING AGENT BEFORE POURING NEW
- 3.5 50mm (MINIMUM) THICK BLINDING LEAN CONCRETE SHALL BE PROVIDED BENEATH FOOTINGS, GROUND BEAMS AND ALL GROUND FLOOR SLABS
- 4. STEEL REINFORCEMENT
- 4.1 THE MINIMUM YIELD STRENGTH OF STEEL REINFORCEMENT (WITH DENOTATION "T")FOR HIGH TENSILE DEFORMED BAR(TYPE 2 - 460 N/mm², STEEL FABRIC - 485 N/mm² (UNLESS OTHERWISE STATED.
- 4.2 THE MINIMUM YIELD STRENGTH OF STEEL REINFORCEMENT
- 5. ALL WATER RETAINING STRUCTURE OR WET AREAS SHALL BE
- 6. IF REQUIRED R.C LINTEL BEAM OF SIZES 150 X 200 REINFORCED WITH 2T12 (T&B) & R6 -150 LINKS SHALL BE PROVIDED TO ALL DOORS AND WINDOWS. STIFFENER, COLUMN SIZES 150X150 TO 200X200 REINFORCED WITH 4T12 & T10-150 LINKS SHALL BE PROVIDED IF REQUIRED. (FOR EG. ON WALL OF MORE THAN 3.5m IN HORIZONTAL LENGTH OR
- 7. INCORPORATING OF M & E REQUIREMENTS IN STRUCTURAL DRAWINGS: THE CONTRACTOR TO PREPARE DETAILED SHOP DRAWINGS INCORPORATING ALL M & E. REQUIREMENTS, OPENINGS ETC INTO THE STRUCTURAL DRAWINGS AND OBTAIN THE PROJECT STRUCTURAL ENGINEER APPROVAL BEFORE PROCEEDING WITH ANY FORM OF PERMANENT CONSTRUCTION WORKS. THE CONTRACTOR SHALL RESOLVE ALL DISCREPANCIES WITH ENGINEERS REGARDING M & E WORKS PRIOR TO CONCRETING.

8. NOTES FOR COMPACTION WORKS OF SUB-BASE AND SUB-GRADE.

- ALL SUB-GRADE AND SUB-BASE LAYING WORKS SHALL BE WELL COMPACTED TO OVER 95% CBR.
- MINIMUM OF FOUR NUMBER OF DRY FIELD DENSITY TESTS AND CBR TESTS SHALL BE CONDUCTED ON COMPACTED SUBGRADES AND SUB-BASE BEFORE CARRYING OUT ANY PERMANENT WORKS SUCH AS CONCRETING OF ACCESS ROAD, GARAGE NON-SUSPENDED FLOOR SLABS & HARD STANDINGS, ETC. THE TESTS RESULTS SHALL BE SUBMITTED TO CIVIL AND STRUCTURAL CONSULTANT ENGINEER FOR REVIEW AND APPROVAL TO PROCEED WITH PERMANENT WORKS (IF APPLICABLE BASIS ONLY).

9.REMOVAL OF FORMWORK

A) THE TIME FOR THE REMOVAL OF FORMWORKS IS TO BE SUBJECTED TO ENGINEER'S APPROVAL,
BUT THE FOLLOWING MAY BE TAKEN AS A GUIDE TO MINIMUM TIMES APPLICABLE UNDER NORMAL CIRCUMSTANCES:

Е	OT THE FULLOWING MAY BE TAKEN AS A GU	JIDE TO MINIMUM	IIIVIE
	SIDE OF COLUMNS/PIERS,WALLS AND BEAMS	3 DAYS	
	SOFFIT OF SLABS (PROPS LEFT UNDER)	14 DAYS	
	PROPS OF SLABS	28 DAYS	
	SOFFIT OF BEAMS (PROPS LEFT UNDER)	14 DAYS	
	PROPS TO SOFFIT OF BEAMS	28 DAYS	

- B) SHUTTERING AND CENTERING SHALL BE REMOVED BY GRADUAL EASING WITHOUT JARRING, AND ONLY IN THE PRESENCE OF A COMPETENT SUPERVISER, BEFORE REMOVAL OF THE SHUTTERING, THE CONCRETE SHALL BE EXAMINED, AND REMOVAL SHALL PROCEED ONLY IF THE CONCRETE HAS ATTAINED SUFFICIENT STRENGTH TO SUPPORT ITS OWN WEIGHT AND ANYCONSTRUCTIONAL OR OTHER LOADS LIKELY TO COME UPON IT. IF ANY LOADING IN EXCESS OF THE DESIGN LOAD IS ANTICIPATED, APPROVED PROPS SHALL BE PROVIDED AFTER REMOVAL OF SHUTTERING
- C) TO ENSURE THAT THE CONSTRUCTIONAL LOADS OF A FLOOR ARE SHARED BY AT LEAST TWO FLOORS BELOW IT, THE PROPS TO THE BEAMS AND SLABS OF A FLOOR SHALL NOT BE REMOVED UNTIL THE FLOOR ABOVE THE FLOOR IN QUESTION, IS STRONG ENOUGH TO SUPPORT ITSELF.

10. GENERAL NOTES FOR PILING WORKS

- ALL PILES TO BE USED FOR THIS PROJECT SHALL BE OF BRUNEI DARUSSALAM MINISTRY OF DEVELOPMENT'S APPROVED TYPES AND BRAND NAMES OR AS PER S.O.'S APPROVAL.
- THE CONTRACTOR SHALL SUBMIT TO THE ENGINEER FOR APPROVAL, BEFORE ANY PILING WORK IS STARTED, DETAILS OF :-
- PILE DRIVER INCLUDING SIZE OF HAMMER AND DROP
- CONTRACTOR'S CALCULATIONS OF SETS, CALCULATED USING THE HILEY FORMULA.
- PROPOSED PROGRAM AND SEQUENCE OF PILE DRIVING INCLUDING
- NO PILING SHALL COMMENCE UNTIL THE SET VALUES SUBMITTED BY THE CONTRACTOR
- ARE APPROVED IN WRITING BY THE ENGINEER.
 THE CALCULATED SETS SHALL ONLY BE USED AS A GUIDE FOR DRIVING AND THE SET SHALL BE CONFIRMED BY THE IN-SITU PILE TEST.
- HOWEVER, PILE HYDRAULIC JACKING TO TWICE THE SAFE WORKING LOAD (MINIMUM) SHALL BE USED IF PILE HAMMERING ACTIVITIES CAUSES DISTURBANCES AND DISTRESS (EXCESSIVE VIBRATIONS) TO SURROUNDING BUILDINGS

11. GENERAL NOTES FOR R.C PILES

R.C PILES

- ALL REINFORCED CONCRETE (R.C.) PRECAST PILES SHALL BE 150MM X 150MM REINFORCED CONCRETE PRECAST PILES OR AS PER SPECIFIED IN THE DRAWINGS
- CONCRETE GRADE SHALL BE GRADE 45 MINIMUM FOR NORMAL R.C. PRECAST PILES.
- THE ALLOWABLE SAFE BEARING CAPACITY OF EACH R.C. PRECAST PILES POIN
- SHALL BE 25 TONNES. THE EXPECTED PENETRATION DEPTH OF EACH PILE POINT IS 6 TO 15 METRES. THIS IS TO BE CONFIRMED DURING PILE DRIVING WORKS. (UNTIL PILE SET IS ACHIEVED
- UNLESS OTHERWISE STATED) THE PILE SET SHOULD BE ACHIEVED WITH THE LAST 10 BLOWS FOR LESS THAN 20mm PENETRATION (PILE HAMMER OF ABOUT ONE TONNE WITH HAMMER DROP OF ABOUT
- 600mm TO ONE METRE) ALL WELDING WORKS FOR JOINING OF PILES SHALL BE CARRIED OUT BY QUALIFIED LICENSED WELDERS
- IF ANY OF THE PILE POINTS DOES NOT PENETRATE 6 METRES DEEP INTO THE GROUND (IF PILE SET IS ACHIEVED AT LESS THAN 6 METRES PENETRATION LENGTH). THE CLIENT OR CONTRACTOR SHALL REPORT TO THE C&S CONSULTANT FOR REDESIGN REQUIREMENT OF THE PILE FOUNDATION.

11a. MILD STEEL TUBULAR PILING

- 11a.1 ALL PILES SHALL BE GRADE 43 SEAMLESS MS TUBES 114.3mm \varnothing x 6.3mm THICK TO B.S. 4848 PART II WITH AN ULTIMATE LOAD CAPACITY OF NOT LESS THAN 240kN.
- 11a.2 ALL PILING WORK SHALL BE CARRIED OUT IN ACCORDANCE TO THE GENERAL SPECIFICATION AS SHOWN IN SPECIFICATION OF MATERIALS AND WORKMANSHIP

12. NOTES FOR PAD FOOTING

- ALL PAD FOOTING CONSTRUCTION SHALL BE REFERRED TO THE PAD FOOTING LAYOUT PLAN N AND DETAILS
- THE DESIGN IS BASED UPON THE GROUND BEARING CAPACITY AT ABOUT 2.0 METRES BELOW EXISTING GROUND LEVEL TO BE 150KN/m
- 3. CONCRETE GRADE 30 SHALL BE USED FOR ALL PAD FOOTING WORKS

13. NOTES FOR BAKAU PILING

- 1. WITH A 1/2 TONNE HAMMER AND DROP OF 900mm. THE FINAL SET SHOULD NOT BE MORE THAN 75/10 BLOWS OR THE SET TO BE FINALISED BY THE ENGINEER DURING THE TEST PILING.
- ALL BAKAU PILES SHOULD BE NOT LESS THAN 75mm Ø (ON AVERAGE), ALL PILES CUT-OFF SHALL BE AT THE LOWEST WATER LEVEL. EXACT LEVEL TO BE DETERMINED ON SITE BY THE ENGINEER
- 3. IF PILE REQUIRED TO BE SPLICED TOGETHER, A TUBULAR SPLICE WITH A HEAVY PIPE 90mm Ø x 600mm LONG x 6mm THICK SHOULD BE USED AT LEAST 4 HOLES SHALL BE PROVIDED IN THE PIPE FOR DRIVING 65mm LONG NAILS SPIKE
- 4. ACTUAL SPACING OF BAKAU PILES TO BE DECIDED ON SITE

14. NOTES FOR SAFETY OF EXISTING UNDER GROUND SERVICES

1. MAIN CONTRACTOR TO CARRY OUT PILOT TRENCHING (ADEQUATE GROUND INVESTIGATION) BEFORE CARRYING OUT ANY EXCAVATION WORKS FOR DRAINAGE WORKS, PILING WOKS AND OTHER WORKS THAT MAY AFFECT THE BURIED (UNDER GROUND) EXISTING SERVICES/UTILITIES SUCH AS ELECTRICAL CABLES, FIBRE OPTIC CABLES, TELECOM CABLES, WATER PIPES. .THIS IS IMPORTANT TO PREVENT ANY DAMAGE TO SUCH SERVICES /UTILITIES SAFETY THREAT TO ALL STATEHOLDERS.

15. NOTES FOR WATERPROOFING WORKS:

- ALL INTERNAL OR EXTERNAL SURFACES OF WATER RETAINING STRUCTURE OR WET AREAS SUCH AS TOILETS, RC ROOF SLABS, RC GUTTERS, M&E ROOMS AND KITCHENS SHALL BE WATERPROOFED WITH APPROVED WATERPROOFING SYSTEM.
 ALL WATERPROOFING WORKS SHALL BE CARRIED OUT BY MANUFACTURER'S APPROVED
- INSTALLER/APPLICATOR AND SHALL BE APPLIED. IN STRICT ACCORDANCE TO THE MANUFACTURER'S APPROVED PROCEDURES OR AS PER ENGINEER'S APPROVAL.
- SUFFICIENT CURING TIME SHALL BE ALLOWED BEFORE INSTALLATION OF ANY PROTECTIVE SCREED OR ARCHITECTURAL FINISHES.
- WATERPROOFING SYSTEMS THAT HAS BEEN APPROVED FOR INSTALLATION SHALL CARRY A 10 YEAR WARRANTY PERIOD BY THE MANUFACTURER OR BY THE MANUFACTURER'S REPRESENTATIVES OR BY THE APPROVED LOCAL DISTRIBUTOR/APPLICATOR.

16. GENERAL NOTES FOR ANY STRUCTURAL STEEL WORKS

- MAIN CONTRACTOR SHALL SUBMIT SHOP DRAWINGS FOR ALL STEEL WORKS FOR STRUCTURAL ENGINEER'S APPROVAL BEFORE ORDERING, PURCHASING, FABRICATING AND ERECTING ANY STEEL STRUCTURAL WORKS
- PROPOSED CONNECTION DETAILS TO BE PROVIDED IN THE STRUCTURAL SHOP DRAWINGS FOR STRUCTURAL ENGINEER'S APPROVAL.
- ALL STEEL SECTION MEMBERS SHALL BE SAND BLASTED BEFORE APPLYING ANY APPROVED ANTI-CORROSION COATING SYSTEM.
- 4. ALL WELDING WORKS SHALL BE CARRIED OUT BY QUALIFIED LICENSED WELDERS.

17. NOTES FOR TURFING

- ALL TURFS SHALL BE 225MM SQUARE FROM AN APPROVED SOURCE FREE FROM LALLANG AND
- BLACK EARTH OF 50MM THICKNESS SHALL BE SPREAD ON TO THE GROUND WHERE TURFING IS
- SPOT TURFING SHALL BE LAID AT 300MM CENTRES.
- CLOSED TURFING TO BANKS SHALL BE PEGGED IN PLACE WITH 25MM DIAMETER PEGS 225MM LONG. ALL TURFING SHALL BE WATERED UNTIL SATISFACTORILY ESTABLISHED AND ALL TURFING THAT HAS BECOME DEFECTIVE WITHIN SIX MONTHS SHALL BE REPLACED AT THE CONTRACTOR'S EXPENSE
- DURING THE PERIOD OF THE WORKS AND MAINTENANCE, THE CONTRACTOR SHALL KEEP ALL TURFED AREAS WATERED, MOWN OR CUT AND CLEARED OF GRASS CUTTING TO THE SATISFACTION OF THE ENGINEER. THE FIRST CUT SHALL BE MADE WHEN THE GRASS IS 100MM HIGH, FOLLOWED BY REGULAR CUTTING SO THAT THE VEGETATION AT NO TIME EXCEEDS 150MM IN HEIGHT.

18. DRAWING NOTE:

ALL STRUCTURAL DRAWING ARE DRAWN TO APPROXIMATE SCALE. ANY DISCREPANCY IN STRUCTURAL DRAWING DIMENSIONS, EXACT DIMENSION SHALL BE REFERRED TO STRUCTURAL ENGINEER

19. GENERAL NOTES FOR FLOOR HARDENER REQUIREMENTS:

ALL CONCRETE SLAB SURFACES WHICH ARE NOT COVERED WITH HEAVY DUTY DECORATIVE TILES AND TO BE USED AS CAR PARKS OR ACCESS ROADS (FOR SELECTED AREAS) SHALL BE APPLIED WITH SUITABLE FLOOR HARDENERS SYSTEM (TO INCLUDE POWER FLOAT TROWELLING IF APPLICABLE)

20. GENERAL NOTES FOR BRICKWALL WORKS:

- ALL BRICKS TO BE USED SHALL BE REGULAR IN SIZE AND APPROVED BY ABCI REINFORCED CONCRETE STIFFENERS (100x100 WITH APPROPRIATE REINFORCEMENTS)SHALL BE PROVIDED AT EVERY INTERVAL OF 3.5m OF BRICK WORK LENGTH

21. NOTES FOR WORKPLACE SAFETY, HEALTH AND ENVIRONMENT COMPLIANCE & INSURANCES & TEMPORARY WORKS:

- MAIN CONTRACTOR SHALL ENSURE TO COMPLY FULLY WITH ALL PREVAILING RULES, REGULATIONS AND LAWS OF NEGARA BRUNEI DARUSSALAM ON WORKPLACE SAFETY, HEALTH AND ENVIRONMENTAL ASPECTS THROUGHOUT THE DURATION OF THE CONSTRUCTION PERIOD AND DEFECTS LIABILITY PERIOD
 2. MAIN CONTRACTOR SHALL ENSURE THAT ALL APPLICABLE INSURANCES ARE VALID THROUGHOUT THE
- CONSTRUCTION PERIOD AND DEFECTS LIABILITY PERIOD SUCH AS CONTRACTOR'S ALL RISK INSURANCE OR OTHERS SUCH AS WORKMEN COMPENSATION INSURANCE POLICY, PUBLIC LIABILITY INSURANCE POLICY AND FIRE INSURANCE POLICY(WHICHEVER IS APPLICABLE AS PER SUPERINTENDING OFFICERS
- 3. MAIN CONTRACTOR SHALL EMPLOY INDEPENDENT CONSULTANT TO CARRYOUT DESIGN WORKS FOR ALL TEMPORARY WORKS AND THAT SUCH TEMPORARY WORKS DESIGN REQUIREMENT ARE FULLY COMPLIED

22. NOTES FOR ROOF TRUSSES:

- ROOF TRUSSES SHALL BE LIGHTWEIGHT PROPRIETARY SYSTEM SUCH AS LYSAGTH SMART TRUSS SYSTEM OR APPROVED TECHNICAL EQUIVALENT SHALL BE DESIGNED BY MANUFACTURER COMPAN
- 2. THE INSTALLATION WORKS SHALL BE CARRIED OUT BY MANUFACTURER'S APPROVED INSTALLER






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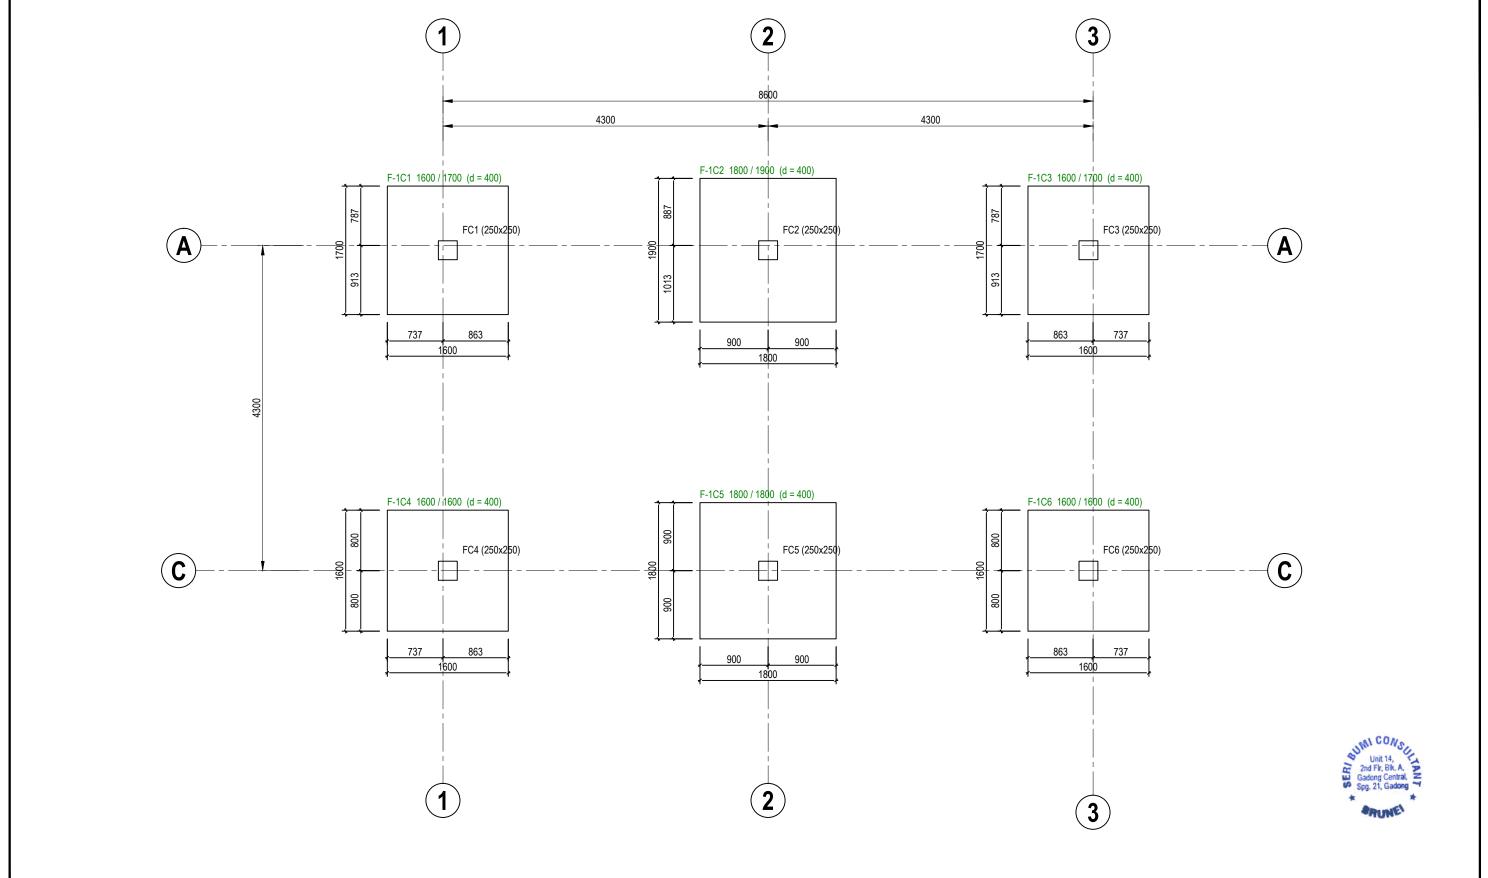
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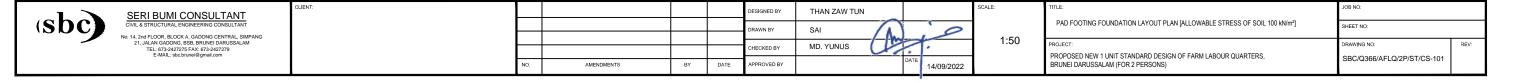
GENERAL NOTES POJECT PROPOSED NEW 1 UNIT STANDARD DESIGN OF FARM LABOUR QUARTERS, BRUNEI DARUSSALAM (FOR 2 PERSONS) SBC/Q366/AFLQ/2P/ST/G - 100







PAD FOOTING FOUNDATION LAYOUT PLAN [ALLOWABLE STRESS OF SOIL 100 kN/m²]


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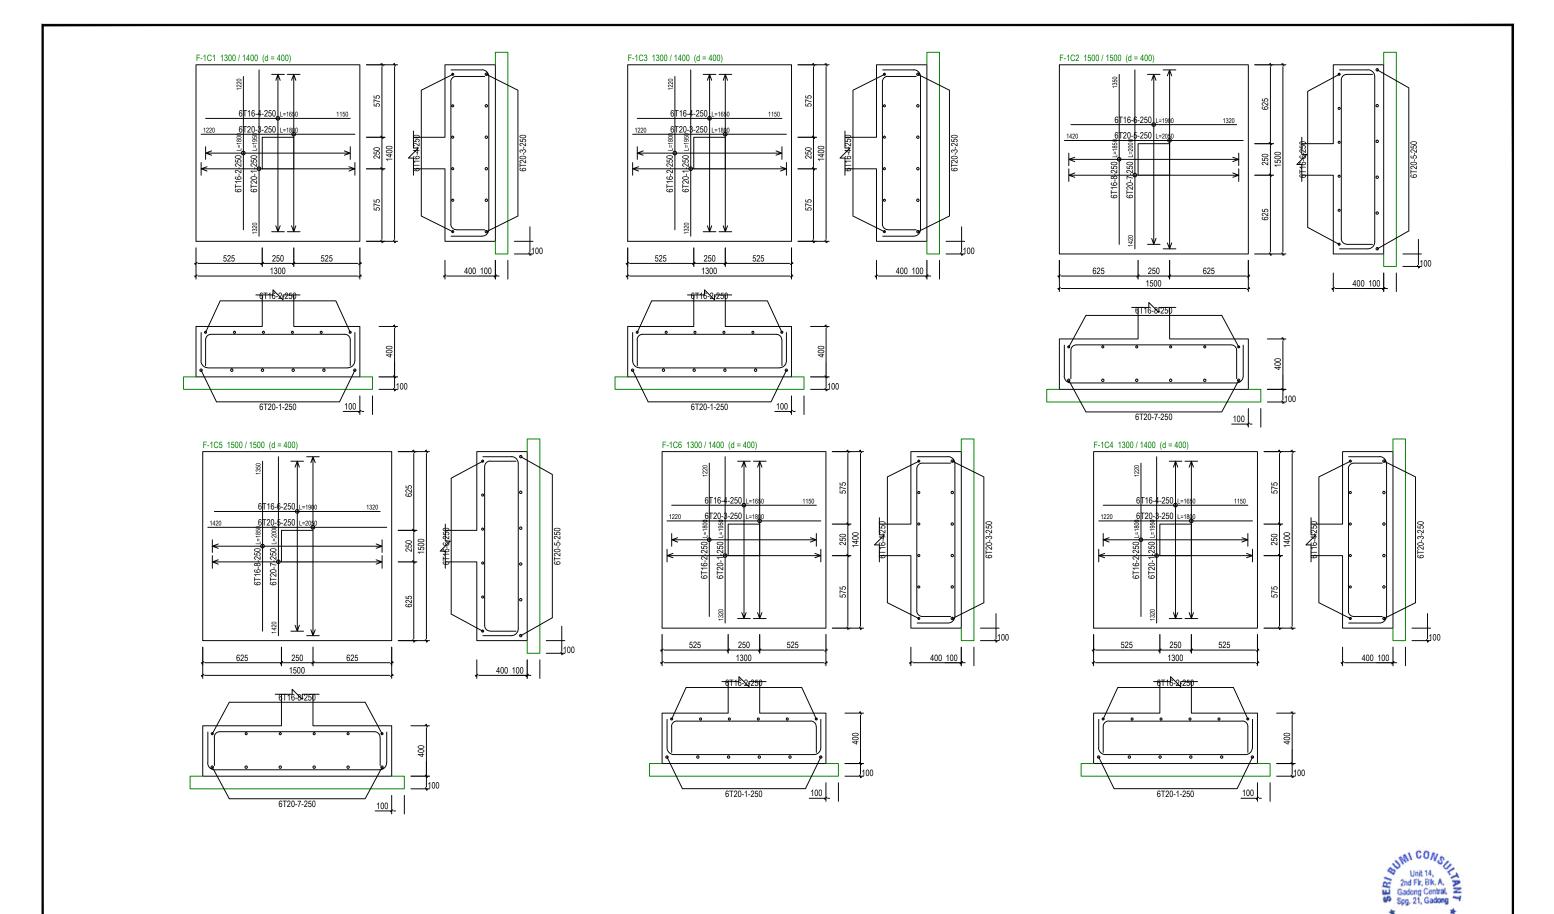


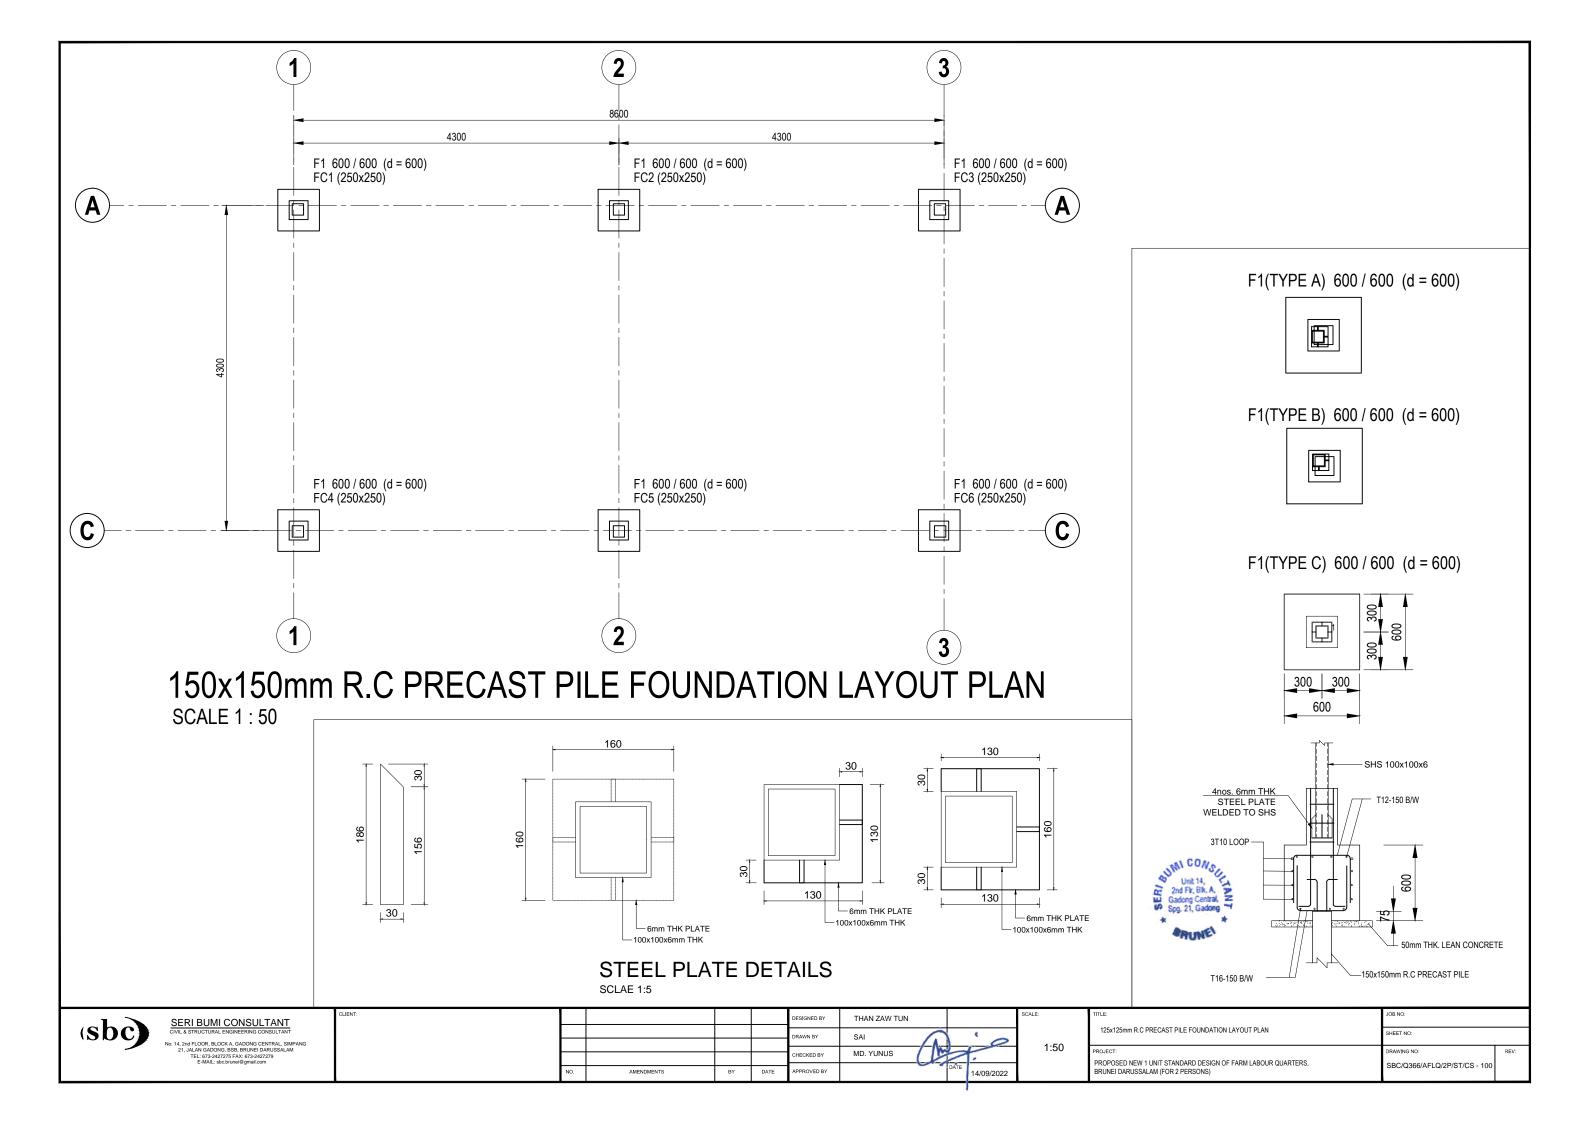

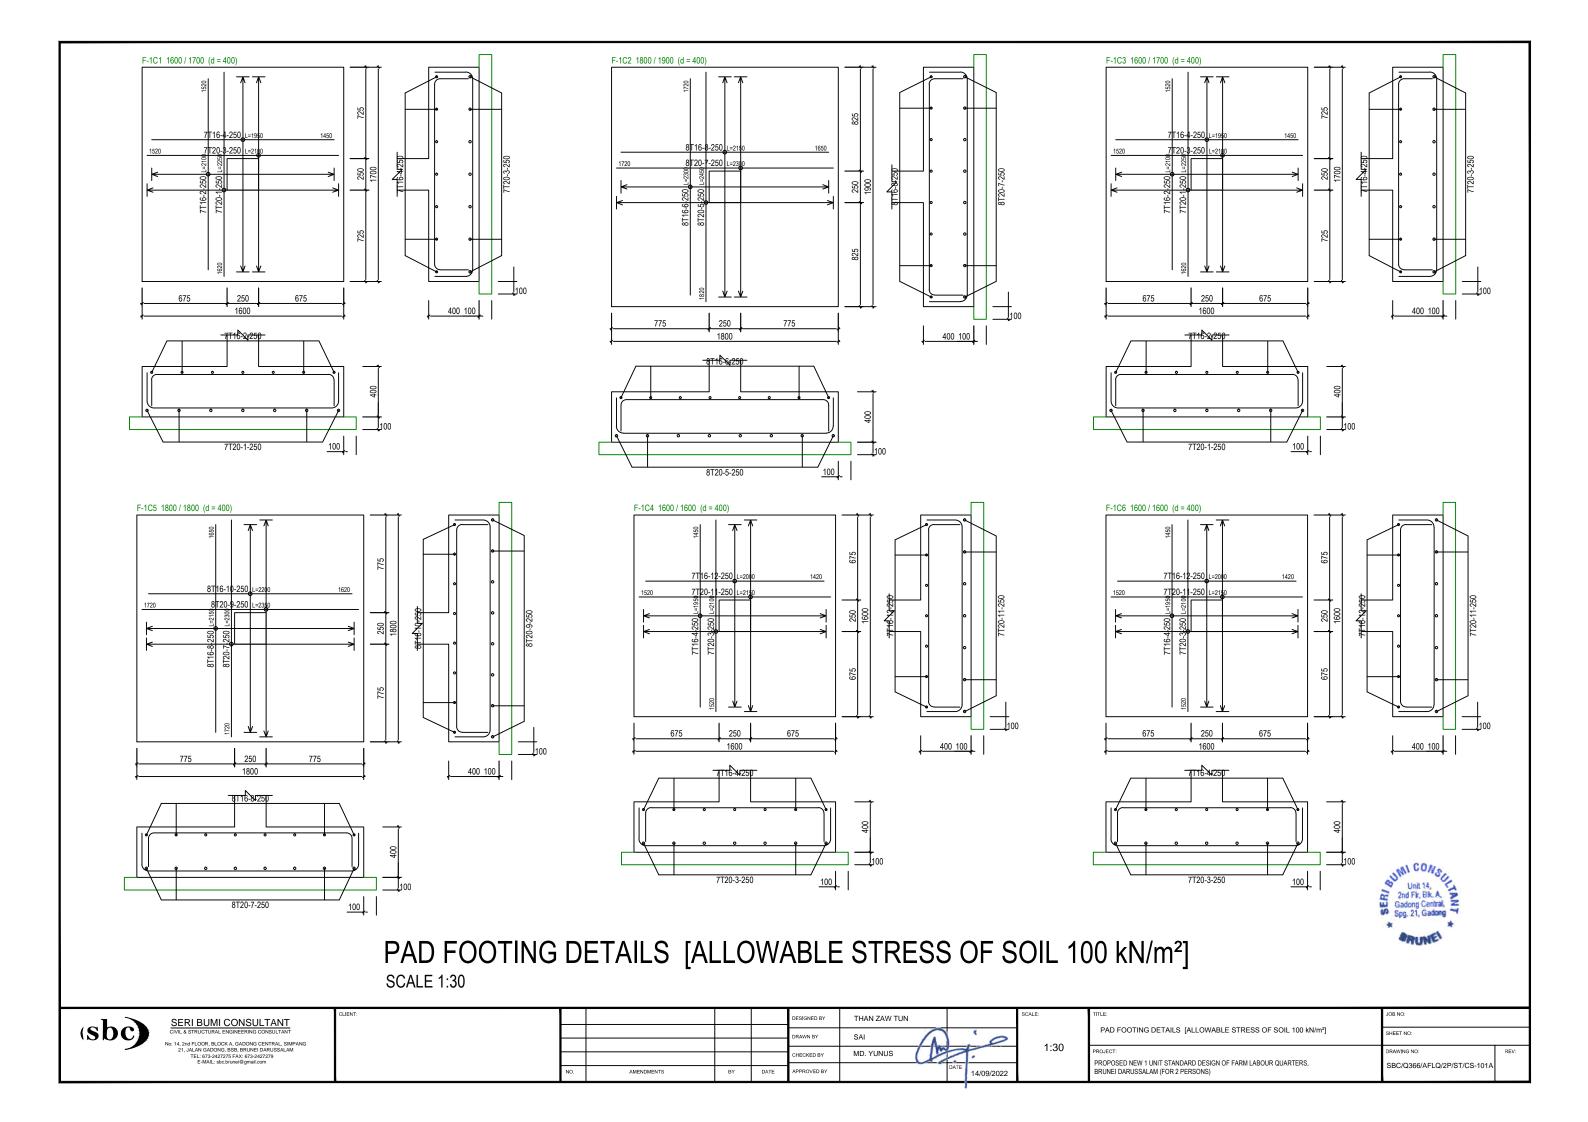

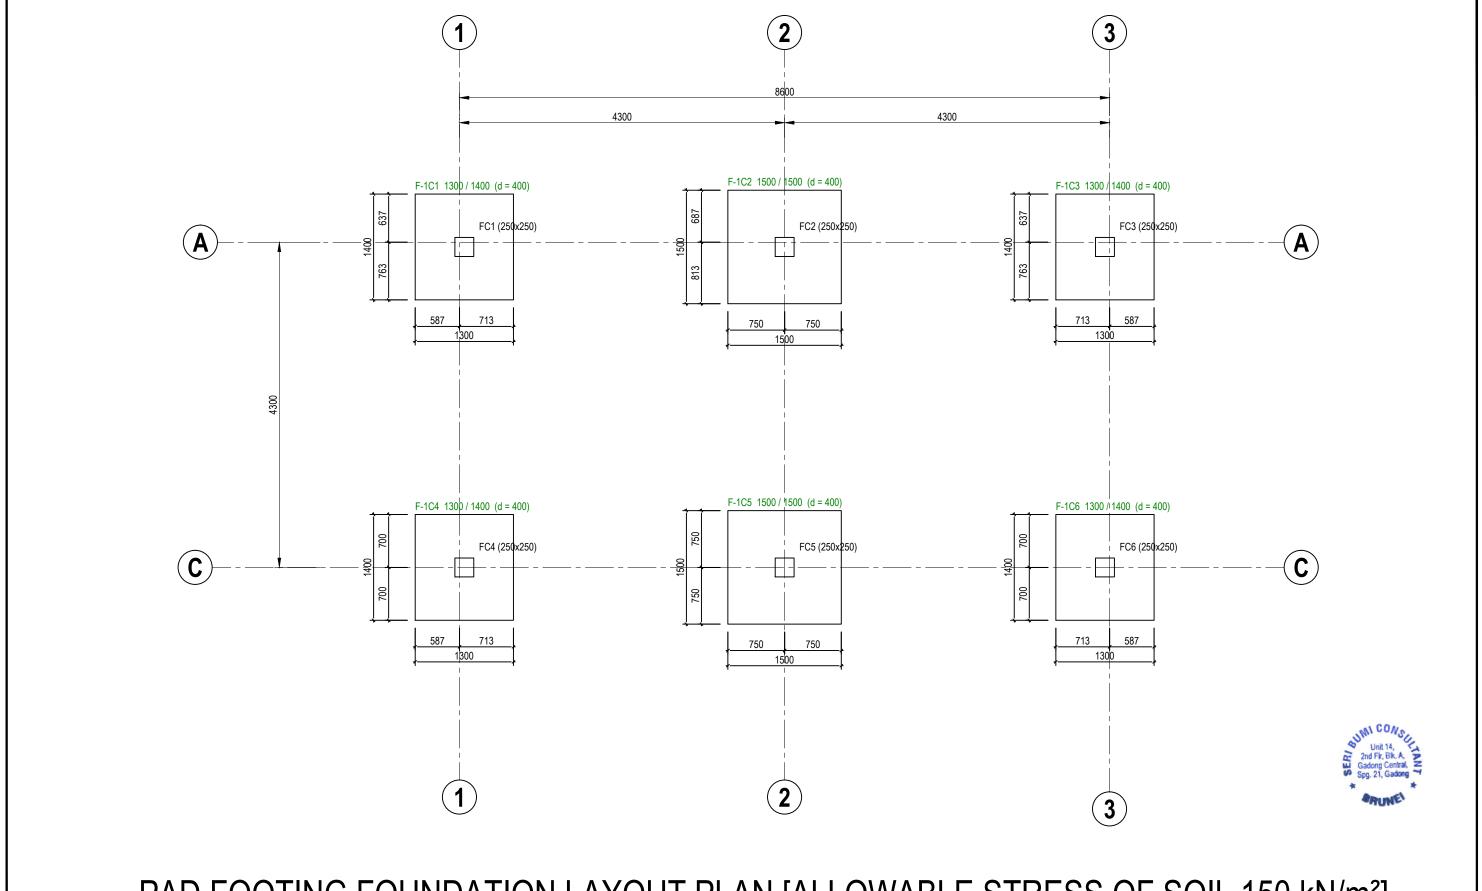PAD FOOTING FOUNDATION LAYOUT PLAN [ALLOWABLE STRESS OF SOIL 150 kN/m²] SCALE 1:50




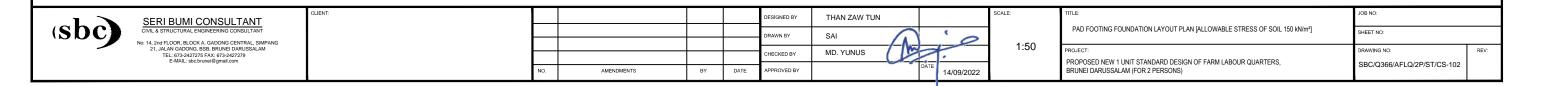


PAD FOOTING DETAILS [ALLOWABLE STRESS OF SOIL 150 kN/m²] **SCALE 1:30**


SERI BUMI CONSULTANT THAN ZAW TUN PAD FOOTING DETAILS [ALLOWABLE STRESS OF SOIL 150 kN/m²] 1:30 MD. YUNUS PROPOSED NEW 1 UNIT STANDARD DESIGN OF FARM LABOUR QUARTERS, BRUNEI DARUSSALAM (FOR 2 PERSONS) SBC/Q366/AFLQ/2P/ST/CS-102A 14/09/2022



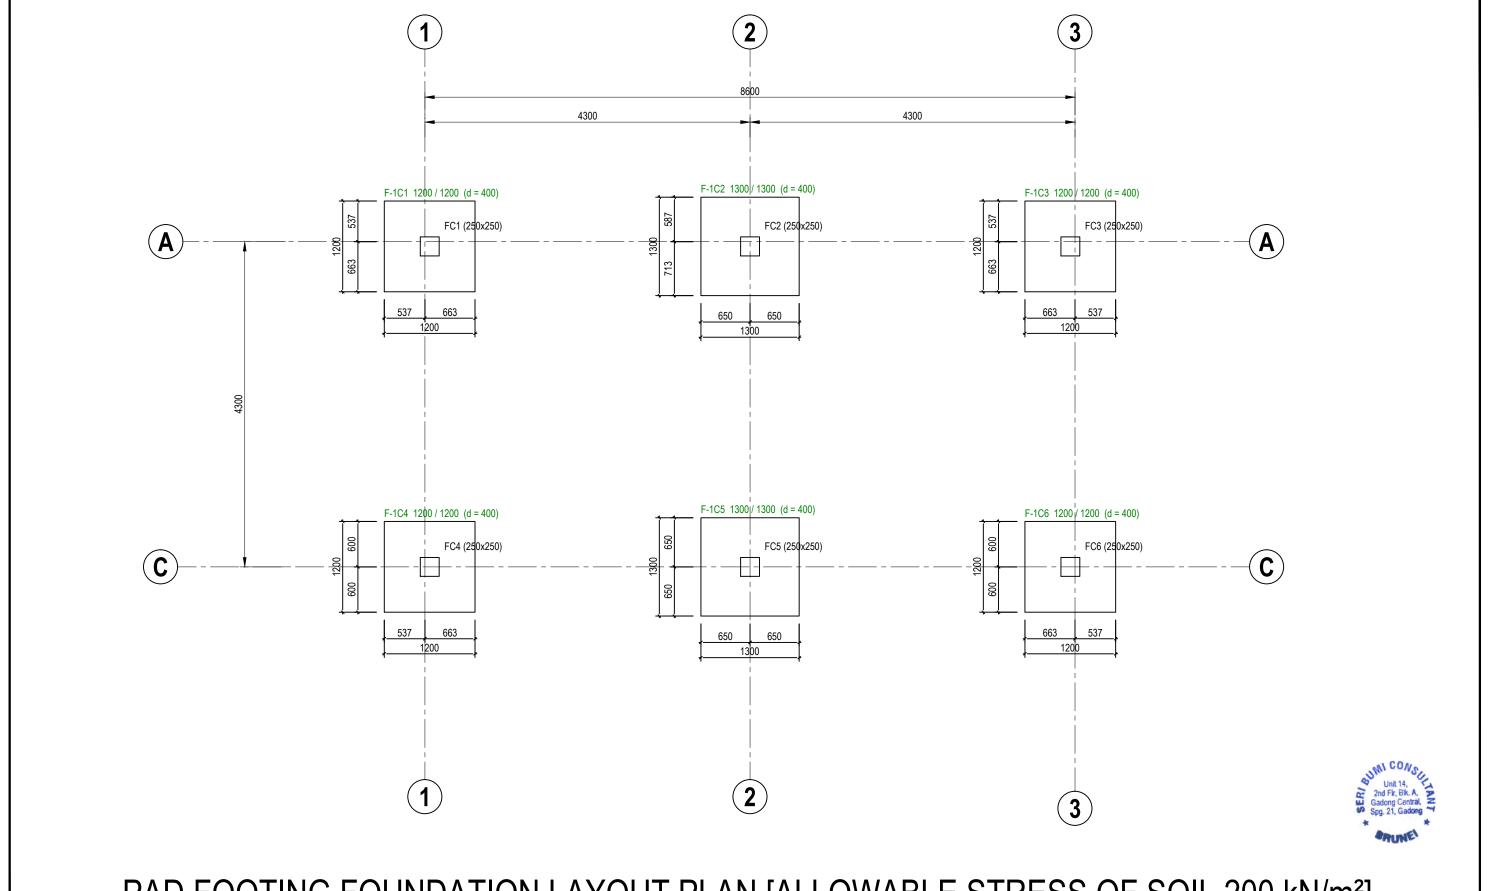


PAD FOOTING FOUNDATION LAYOUT PLAN [ALLOWABLE STRESS OF SOIL 200 kN/m²] SCALE 1:50

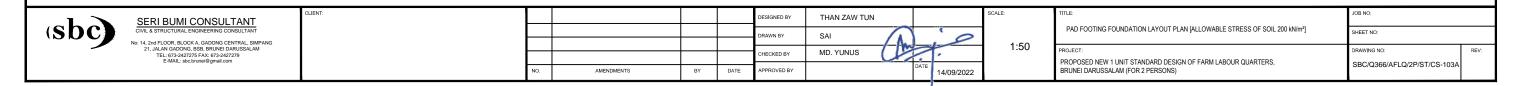

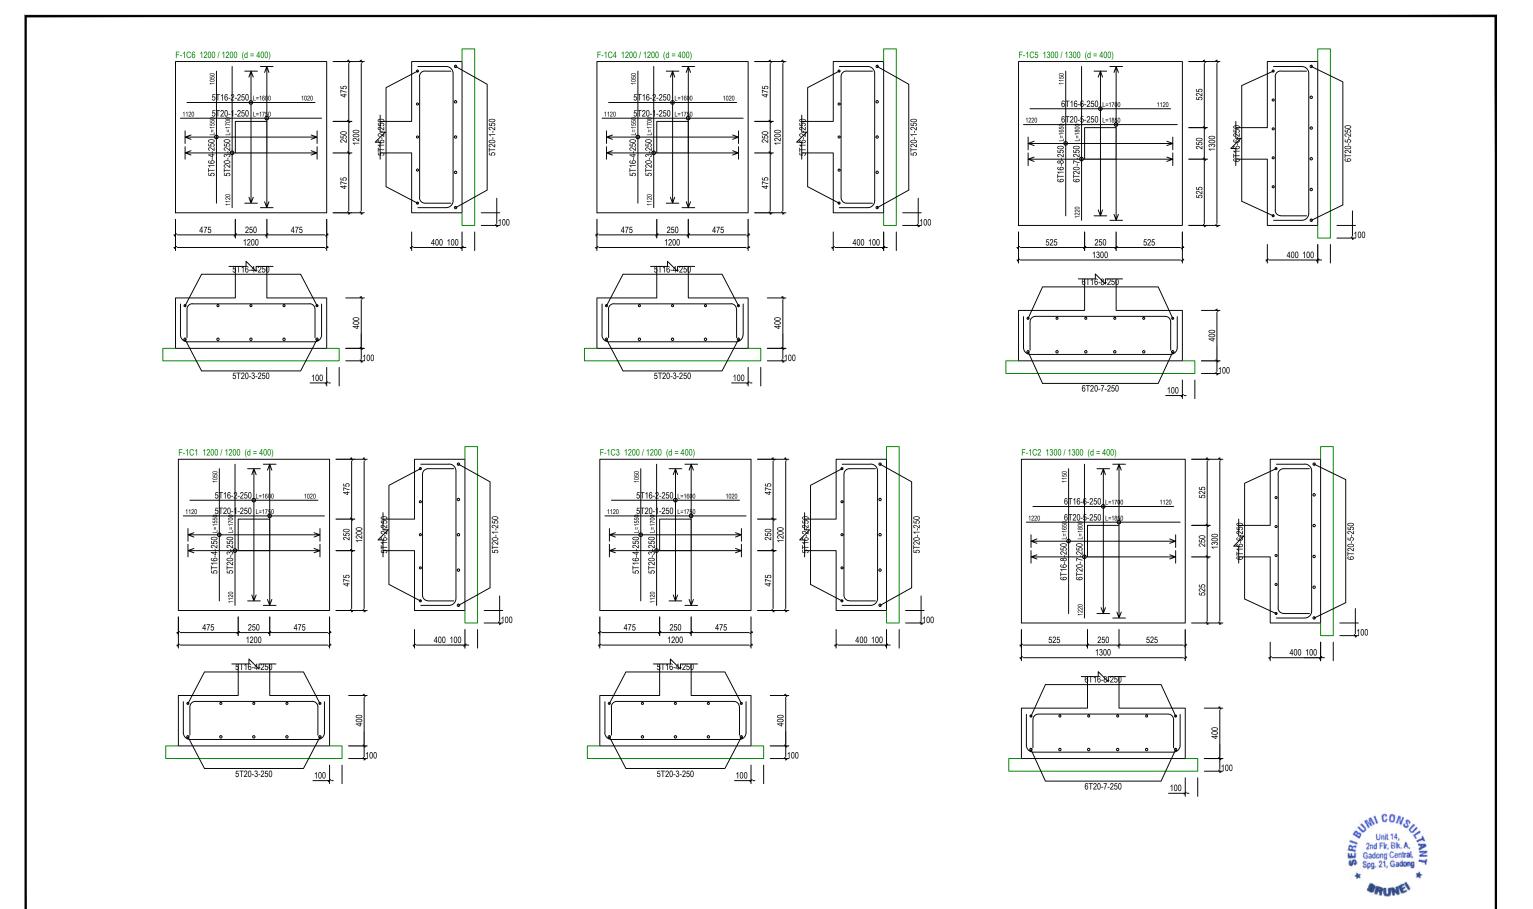

PAD FOOTING DETAILS [ALLOWABLE STRESS OF SOIL 200 kN/m²]


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21, JALAN GADONG, BSB, BRUNEI DARUSSALAM TEL: 673-2427275 FAX: 673-2427279 E-MAIL: 50-burnei@gmail.com					CHECKED BY	MD. YUNUS		•	IV. I . S	PROJECT: PROPOSED NEW 1 UNIT STANDARD DESIGN OF FARM LABOUR QUARTERS,	DRAWING NO:	REV:
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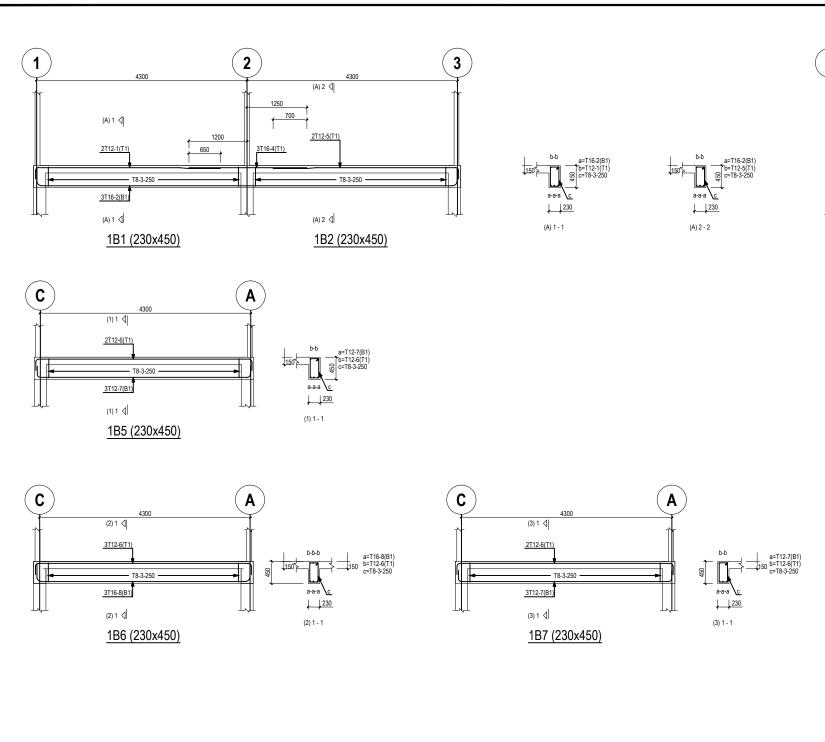


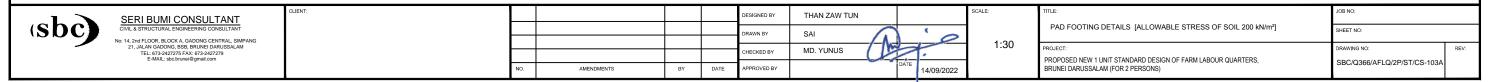
GROUND FLOOR BEAM LAYOUT PLAN

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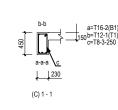


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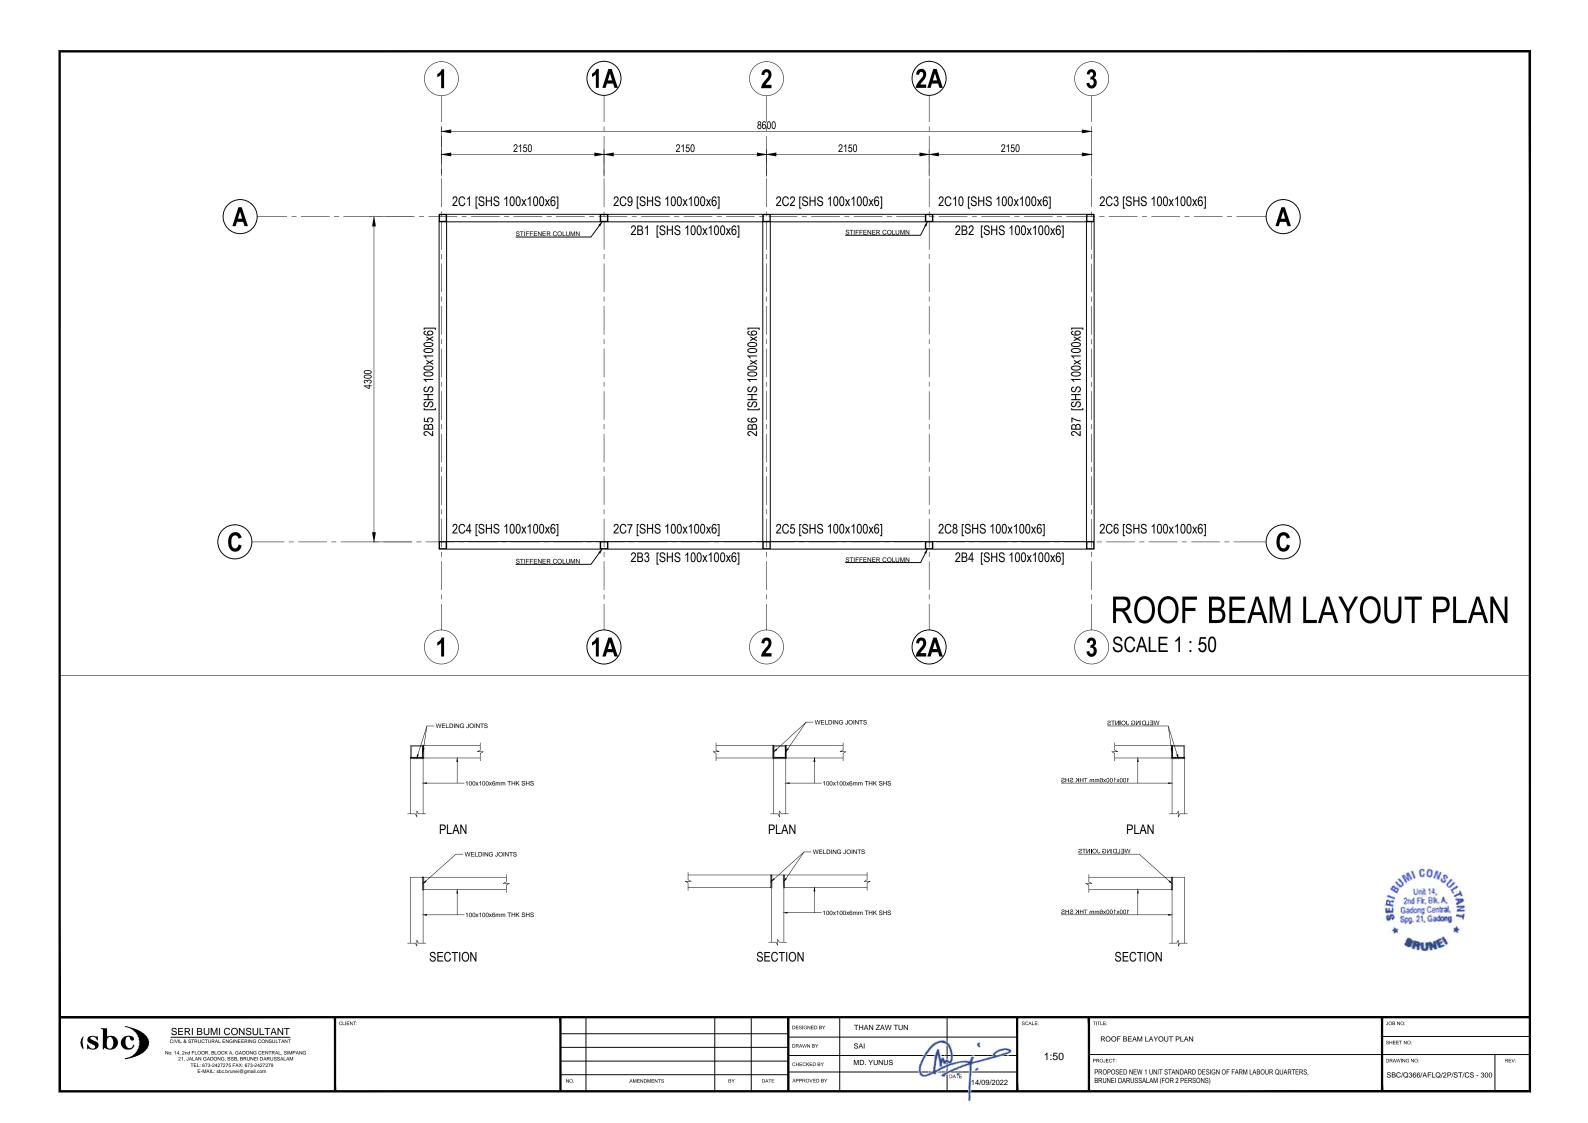
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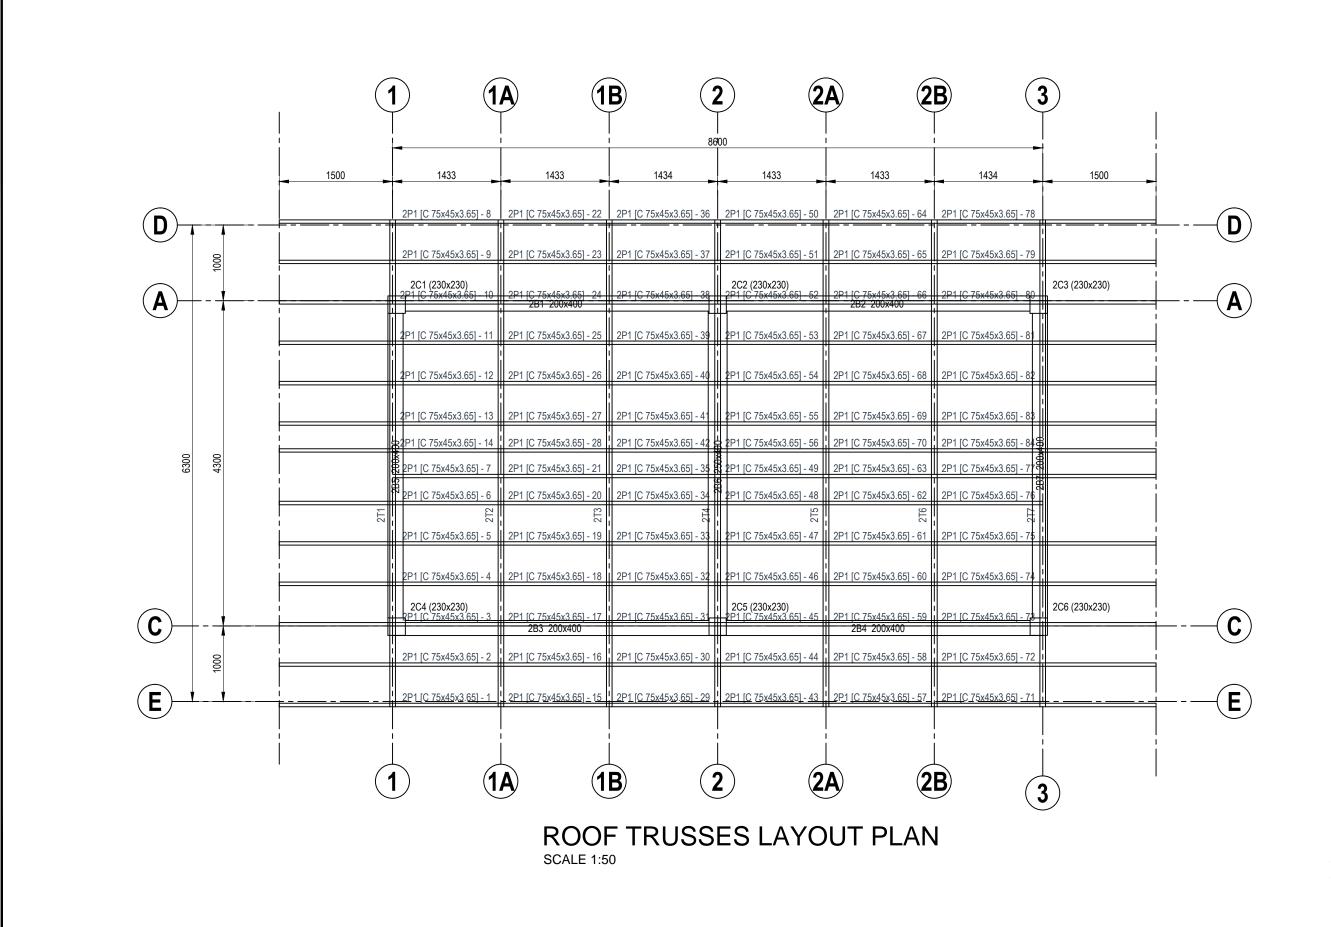


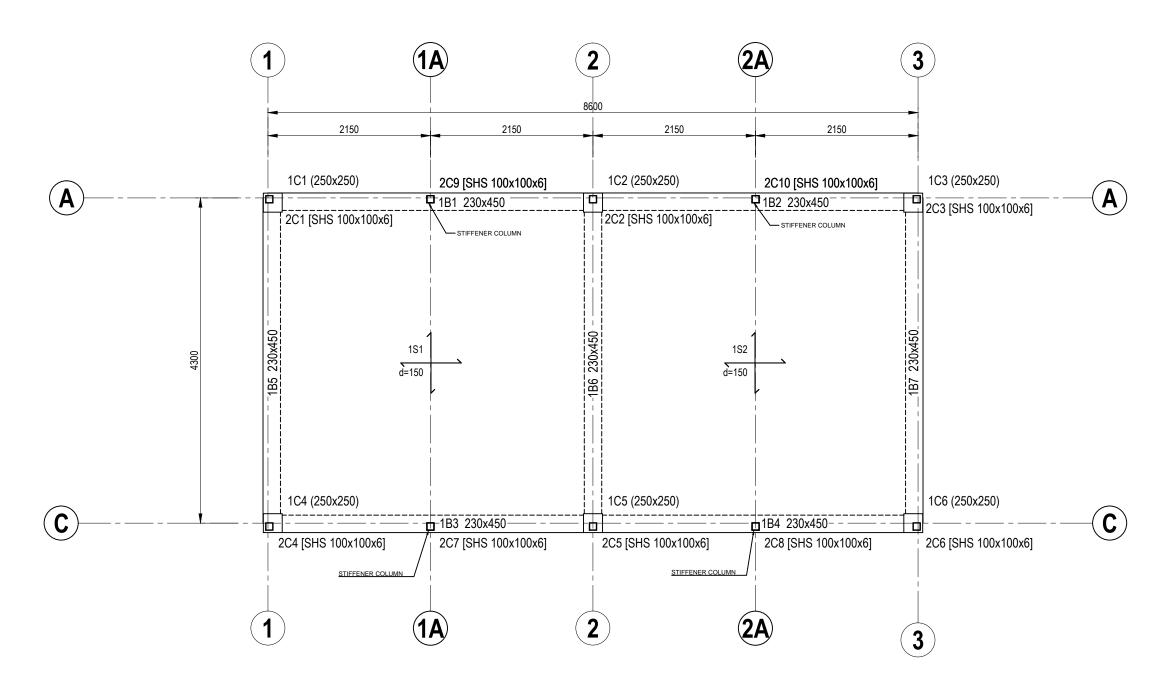


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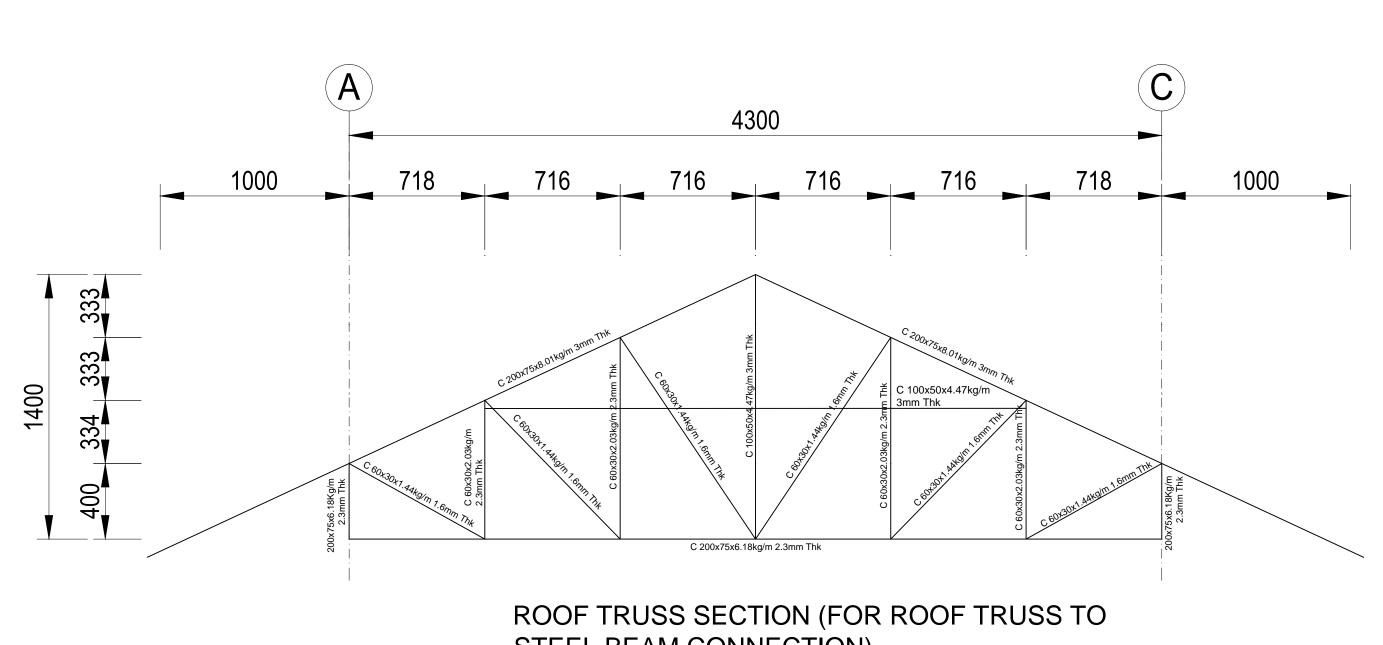
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PROPOSED NEW 1 UNIT STANDARD DESIGN OF FARM LABOUR QUARTERS, BRUNEI DARUSSALAM (FOR 2 PERSONS)	SBC/Q366/AFLQ/2P/ST/CS - 201				

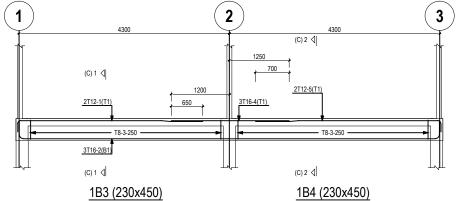







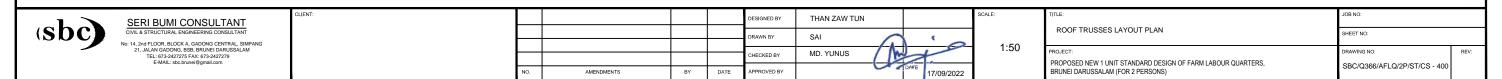



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PROPOSED NEW 1 UNIT STANDARD DESIGN OF FARM LABOUR QUARTERS, BRUNEI DARUSSALAM (FOR 2 PERSONS)

DRAWING LIST

ITEM	DRAWING NUMBER	DRAWING TITLE
1	JOMC/254/FH/100	SITE DEVELOPMENT PLAN FIRE HYDRANT LAYOUT PLAN - (FOR 2 PERSONS)
2	JOMC/254/AC/200	GROUND FLOOR AIR CONDITIONING LAYOUT - (FOR 2 PERSONS)
3	JOMC/254/L/200	GROUND FLOOR LIGHTING LAYOUT - (FOR 2 PERSONS)
4	JOMC/254/P/200	GROUND FLOOR POWER LAYOUT - (FOR 2 PERSONS)
5	JOMC/254/P/300	SOLAR SYSTEM LAYOUT DIAGRAM - (FOR 2 PERSONS)
6	JOMC/254/F/200	GROUND FLOOR FIRE PROTECTION LAYOUT - (FOR 2 PERSONS)
7	JOMC/254/T/200	GROUND FLOOR TELEPHONE LAYOUT - (FOR 2 PERSONS)
8	JOMC/254/T/300	TELEPHONE SYSTEM SCHEMATIC DIAGRAM - (FOR 2 PERSONS)
9	JOMC/254/W/200	GROUND FLOOR PLUMBING LAYOUT - (FOR 2 PERSONS)
10	JOMC/254/W/300	PLUMBING SCHEMATIC DIAGRAM - (FOR 2 PERSONS)
11	JOMC/254/SEW/200	GROUND FLOOR SANITARY LAYOUT - (FOR 2 PERSONS)
12	JOMC/254/SEW/300	SANITARY SCHEMATIC DIAGRAM - (FOR 2 PERSONS)
13	JOMC/254/SEW/301	SANITARY SEWER LINE INVERT LEVEL - (FOR 2 PERSONS)

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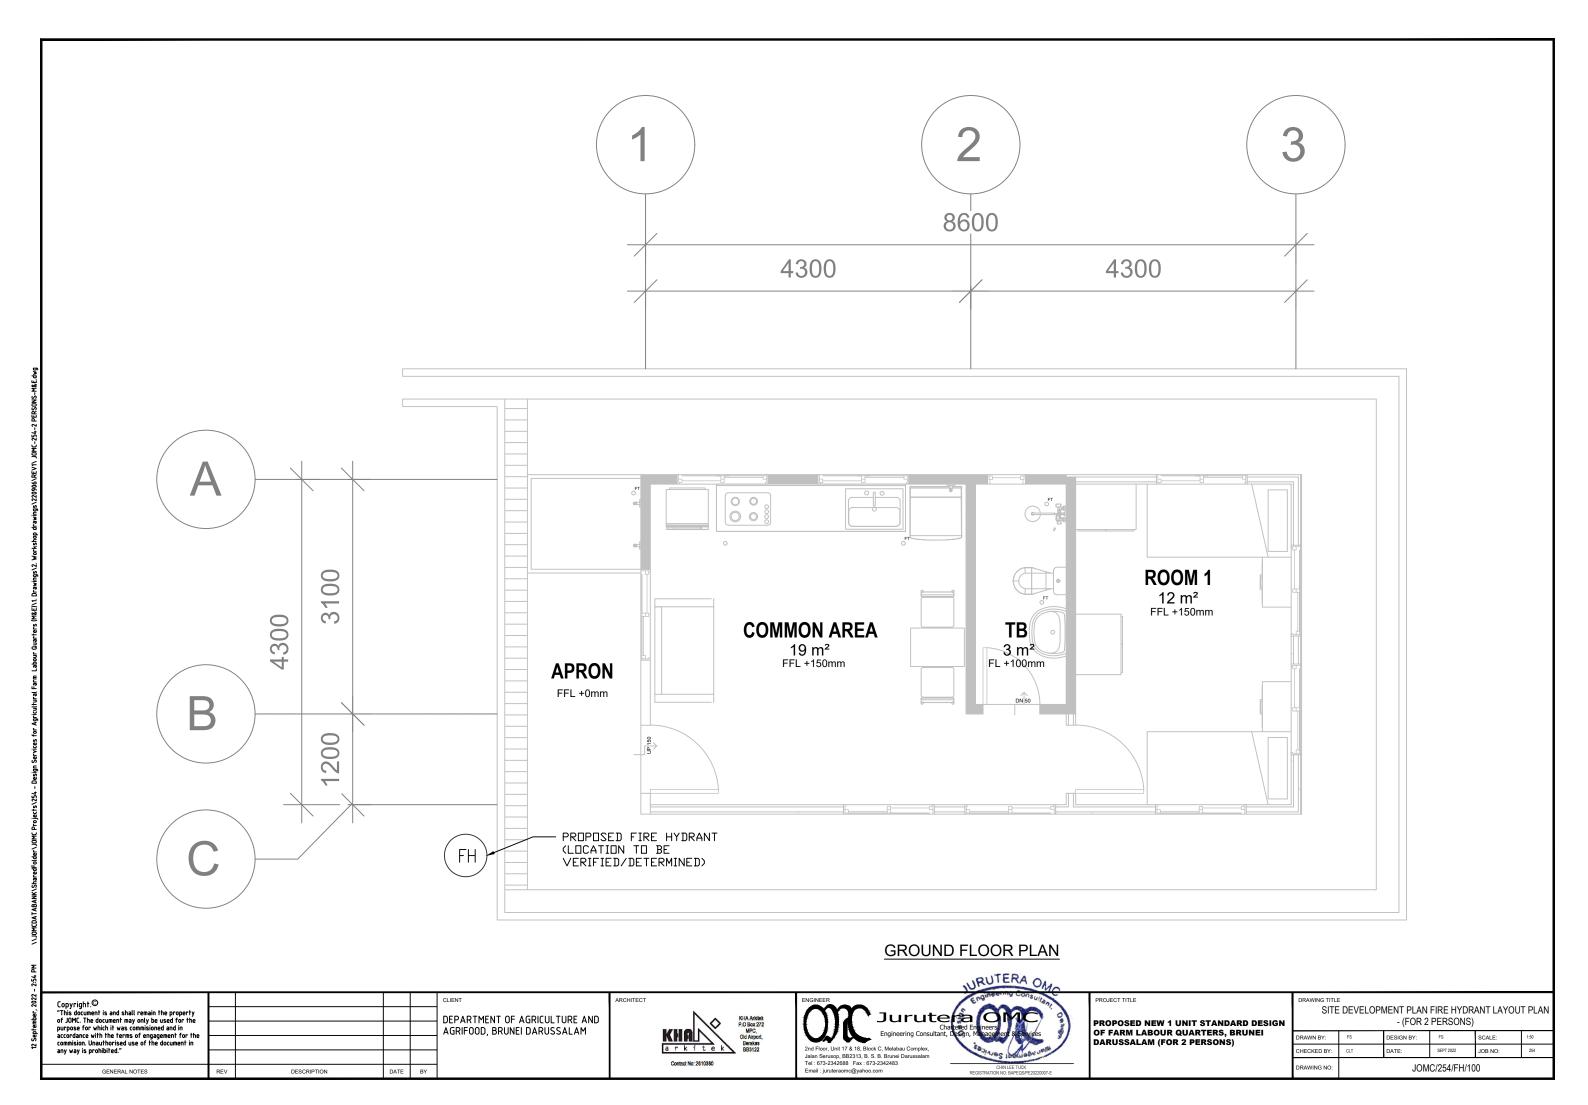


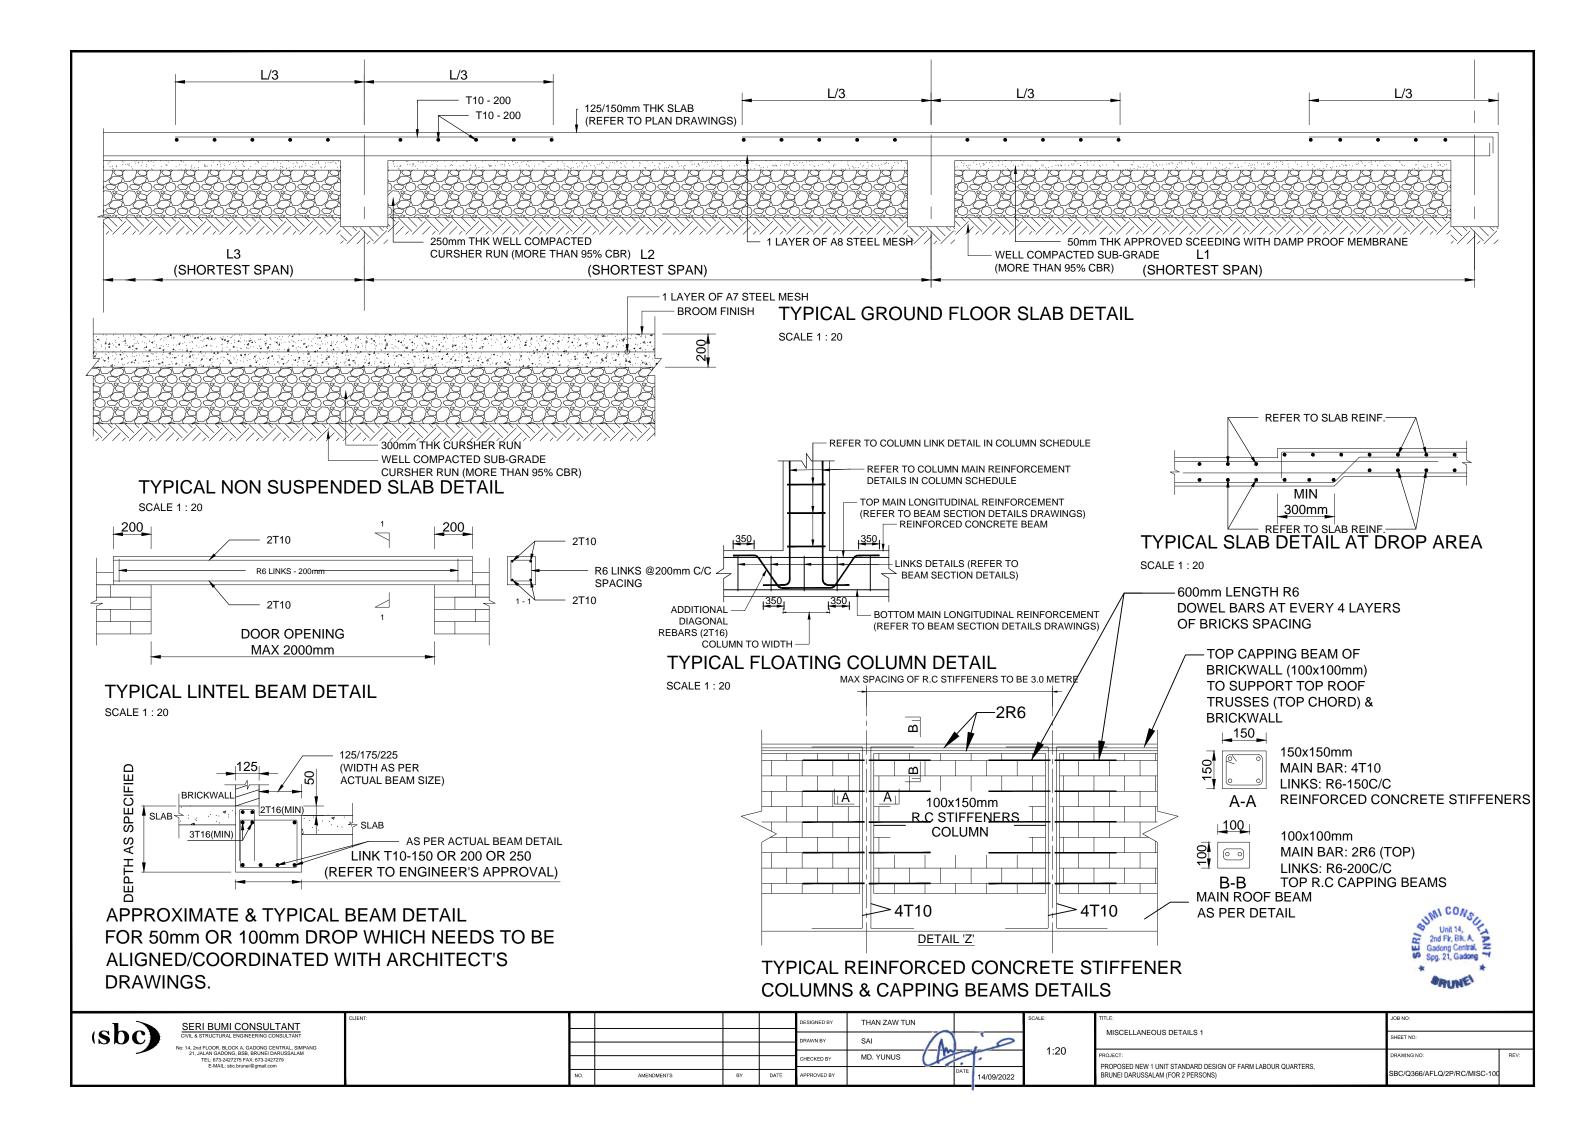
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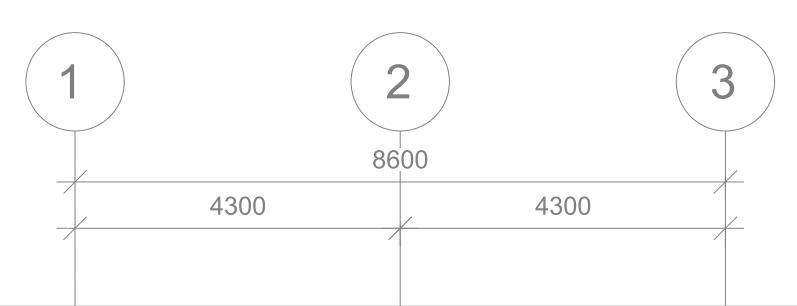
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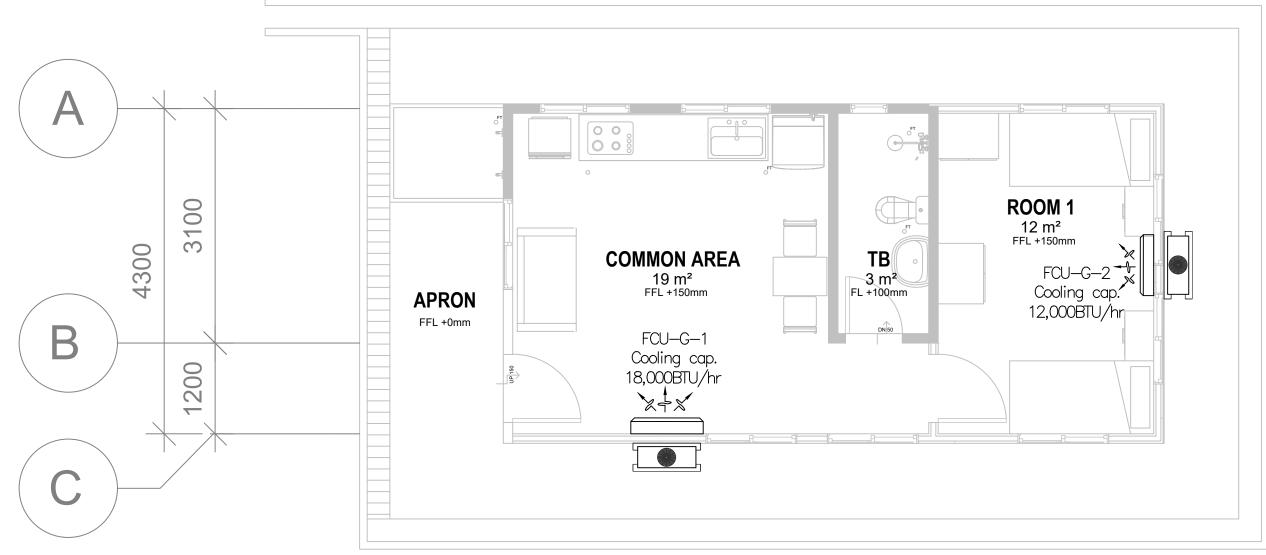
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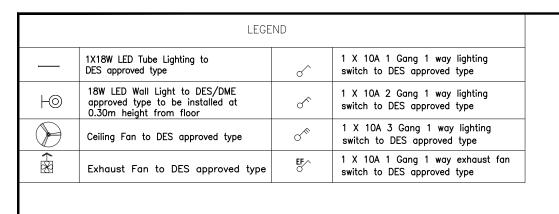


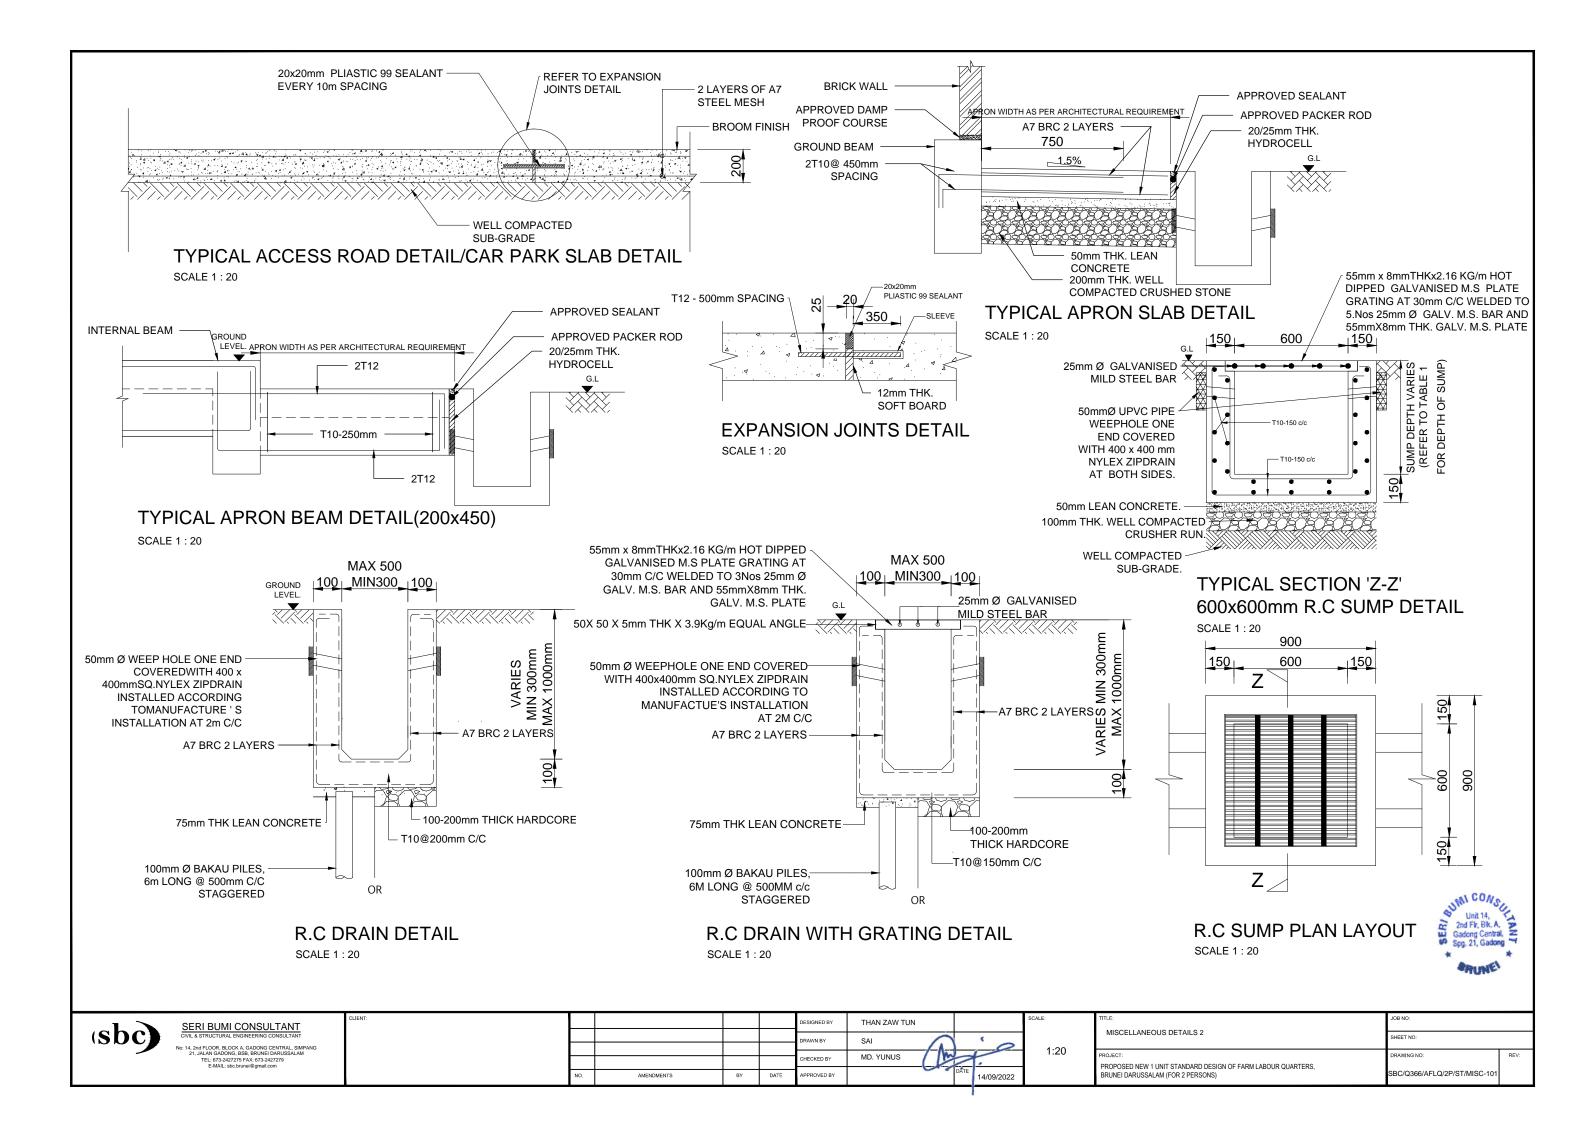



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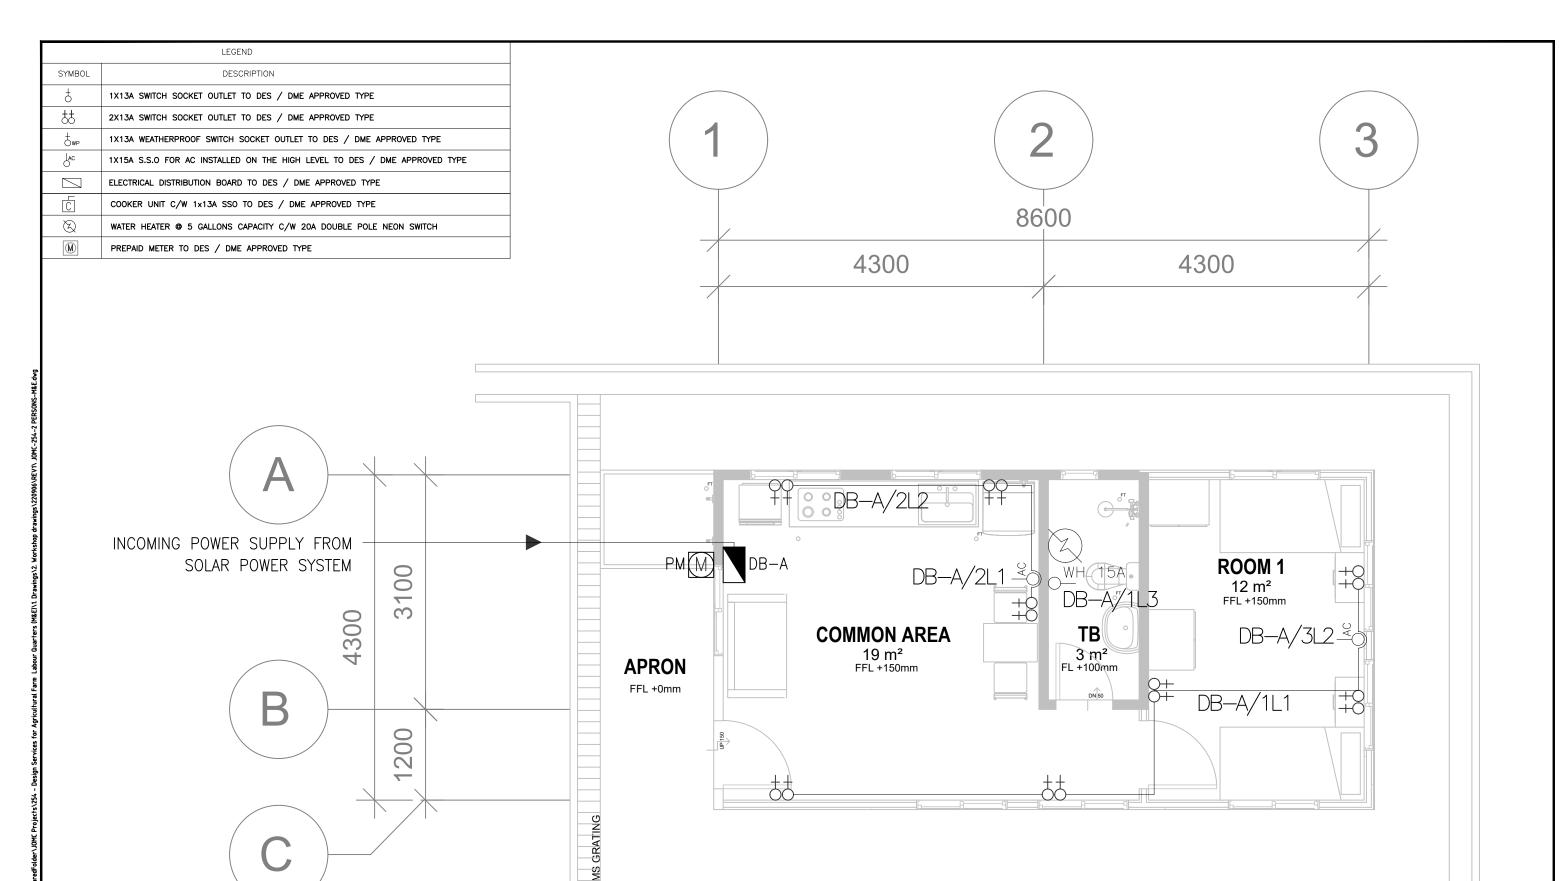
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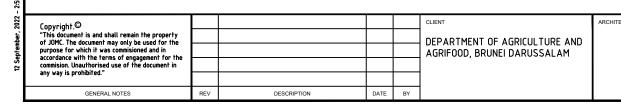




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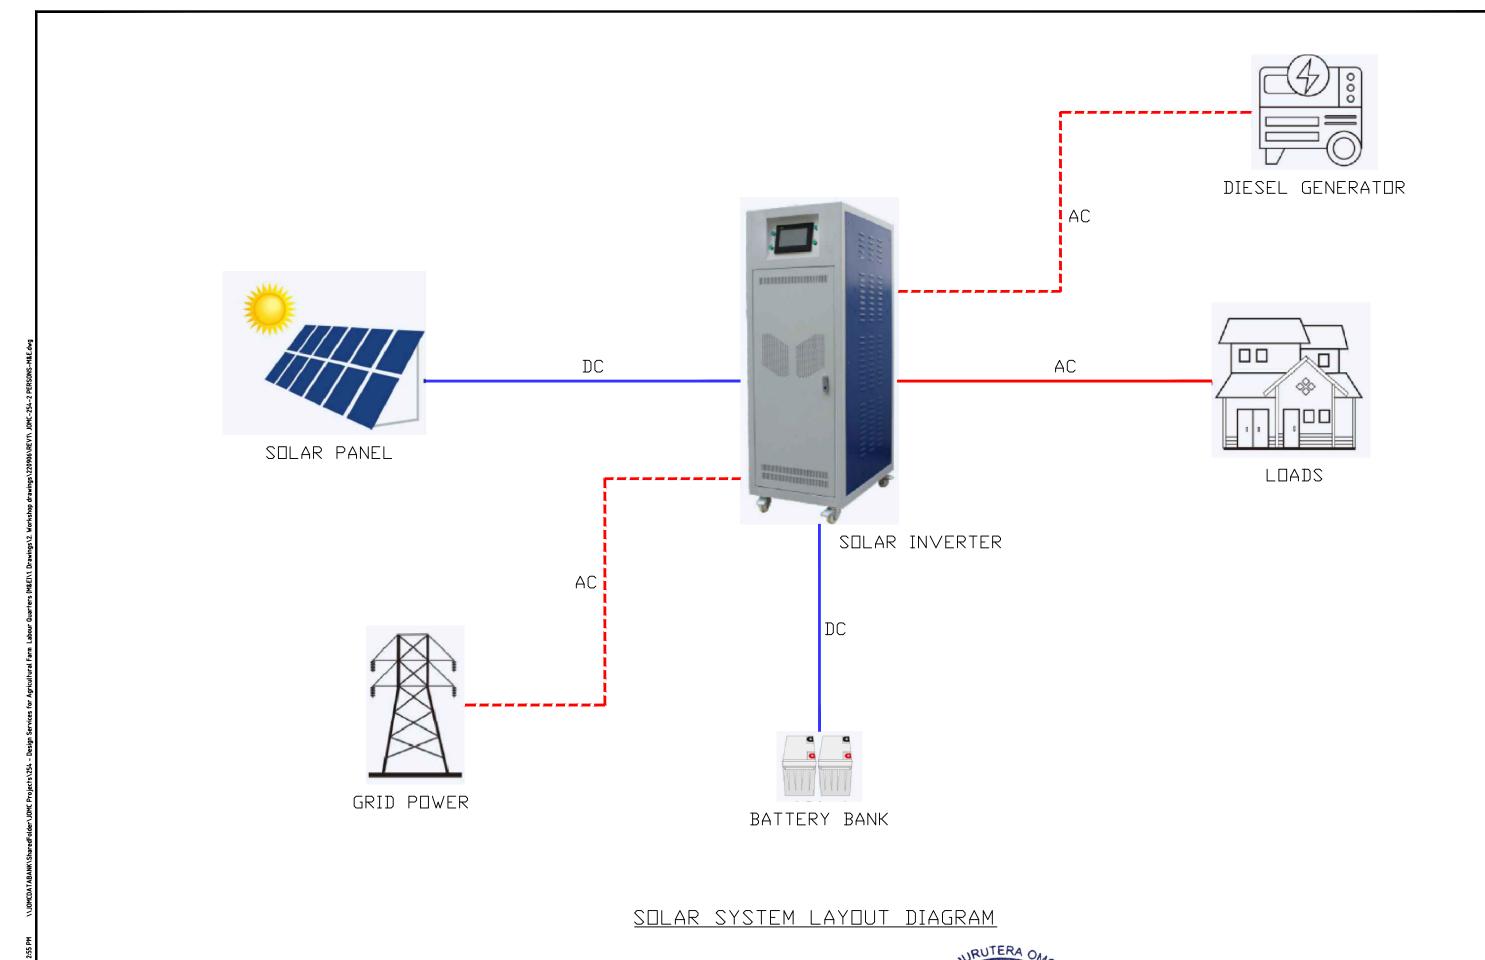


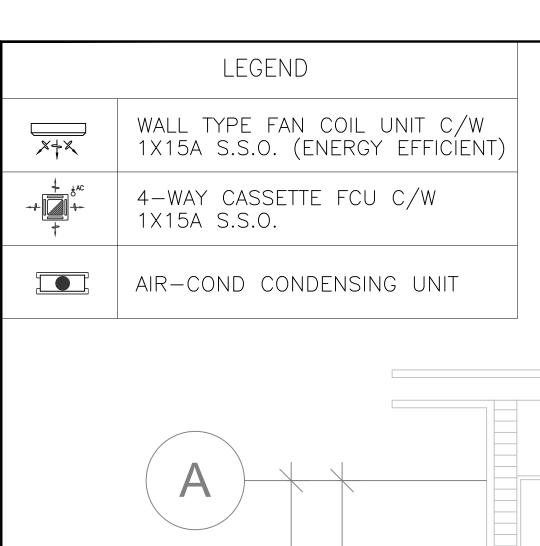

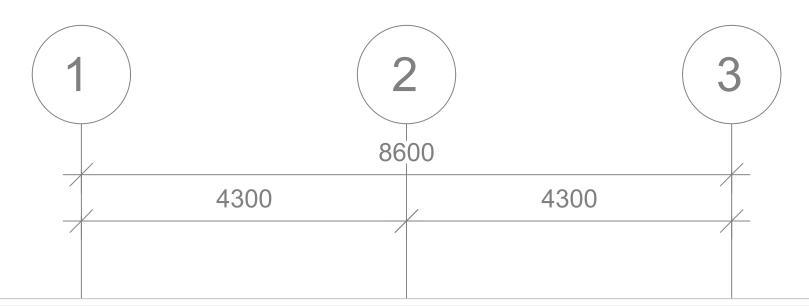
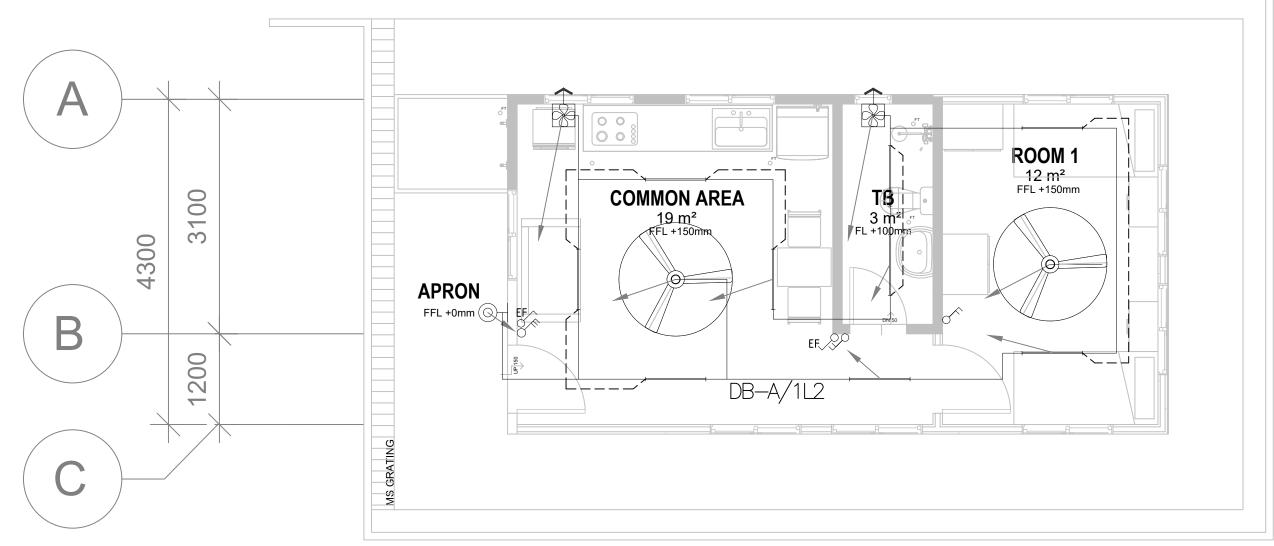
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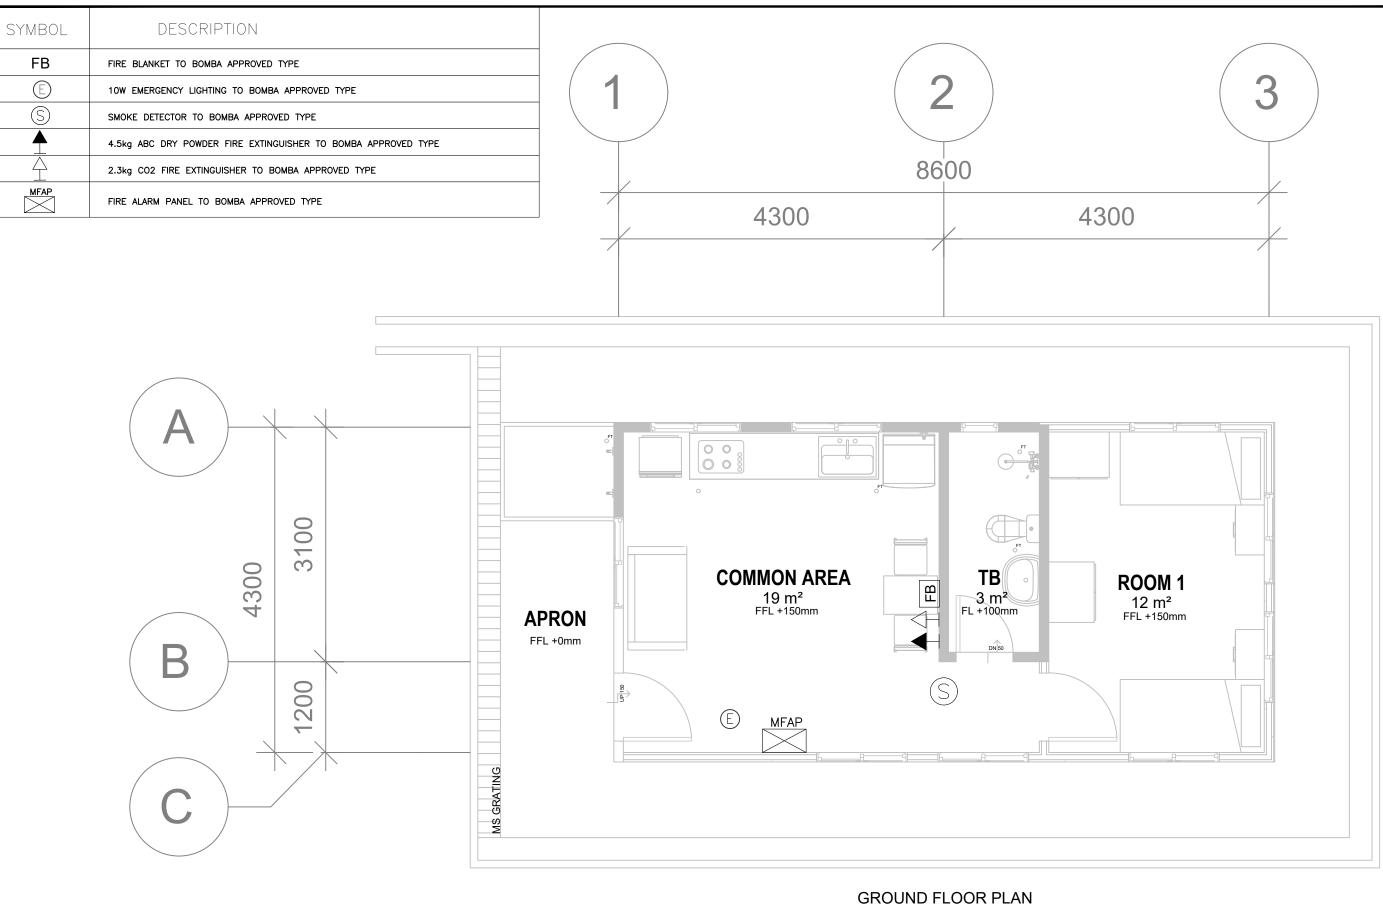
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DEPARTMENT OF AGRICULTURE AND AGRIFOOD, BRUNEI DARUSSALAM





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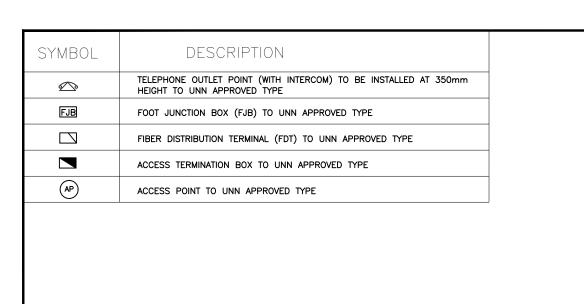






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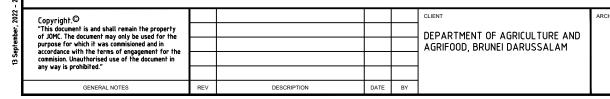
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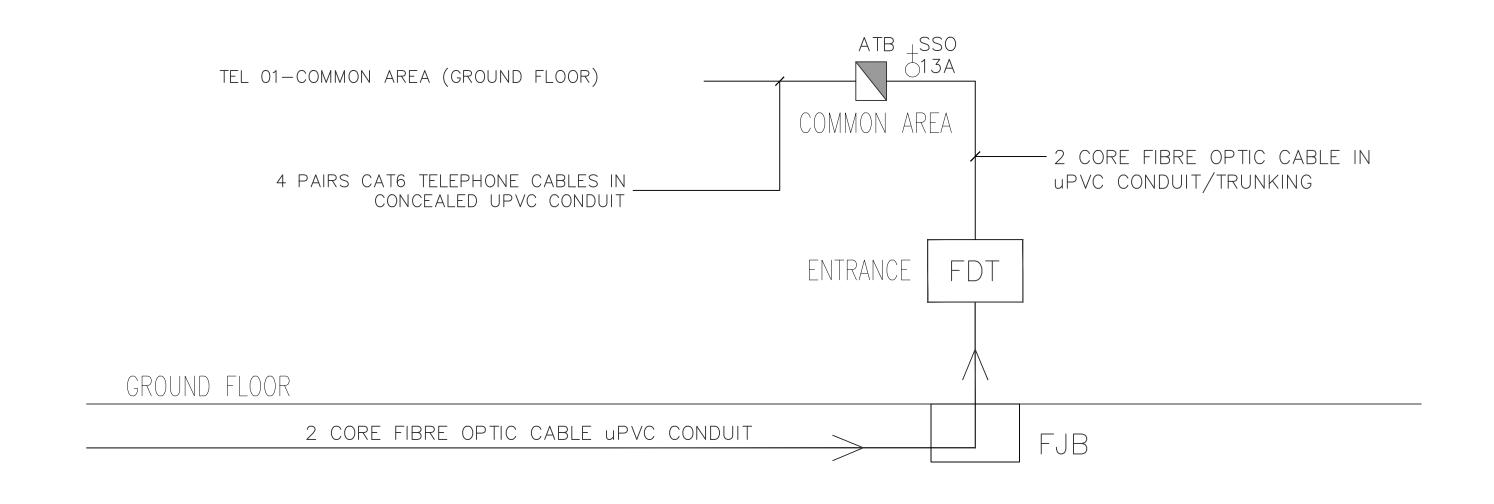
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PROPOSED NEW 1 UNIT STANDARD DESIGN
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DRAWING NO:



TELEPHONE SYSTEM SCHEMATIC DIAGRAM

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GENERAL NOTES
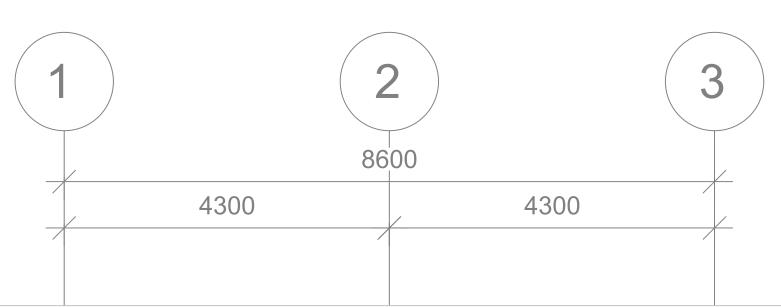
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Contact No: 26 10380

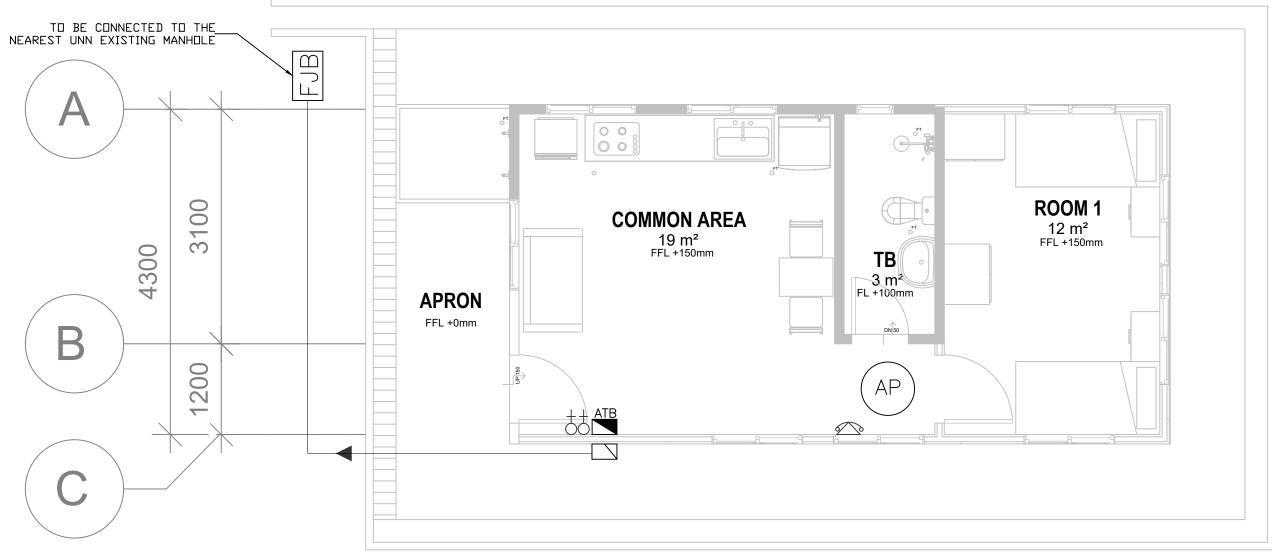DEPARTMENT OF AGRICULTURE AND

AGRIFOOD, BRUNEI DARUSSALAM



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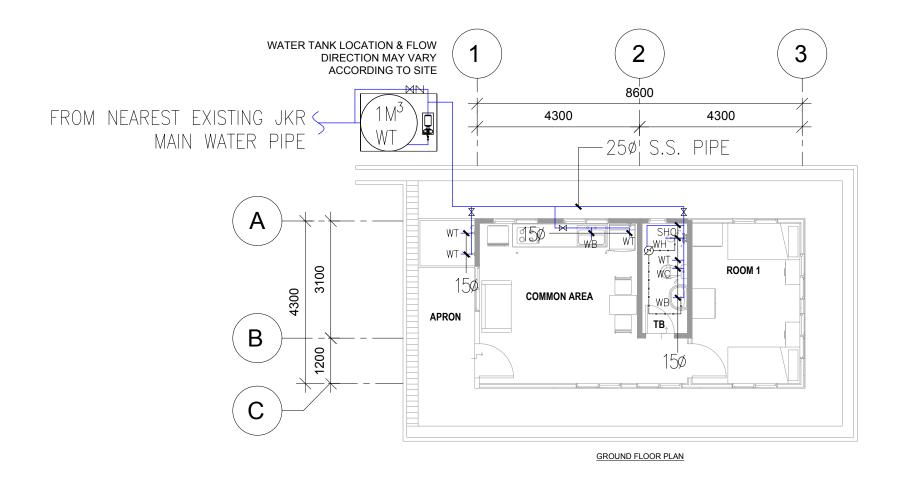
 TELEPHONE SYSTEM SCHEMATIC DIAGRAM - (FOR 2 PERSONS)

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 DATE:
 SEPT 2022
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LEGEND	
\bowtie	Gate Valve
KS	Kitchen Sink
WC	Water Closet
WT	Water Tap
WB	Water Basin
	Cold Water
	Hot Water



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PROPOSED NEW 1 UNIT STANDARD DESIGN OF FARM LABOUR QUARTERS, BRUNEI DARUSSALAM (FOR 2 PERSONS)

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NOTES:

HOT WATER PIPEWORK

- 1. ALL HOT WATER PIPEWORK TO BE COPPER TO BS 2871: 1971 M TABLE X. JOINTS COMPRESSION FITTING TO BS 864: PART 2: 1983 TYPE A.
- 2. HOT WATER PIPEWORK EMBEDDED IN WALL SHALL BE DENSO OR POLYETHLENE WRAPPED.
- 3. HOT WATER PIPEWORK NOT EMBEDDED IN WALL TO BE INSULATED WITH 25MM PREFORMED FIBRE GLASS INSULATION WITH FACTORY APPLIED ALUMINIUM JACKET SEAL JOINTS WITH PRESSURE SENSITIVE TAPE.

COLD WATER PIPEWORK

- 1. ALL COLD WATER PIPEWORK ABOVE GROUND TO BE:
- i) BELOW 80 MM

PIPEWORK TO BE STAINLESS STEEL TO BS 4127.

JOINTS COMPRESSION & FITTINGS TO

BS 864: PART 2.

- 2. ALL COLD WATER PIPEWORK BURIED UNDERGROUND TO BE:
- i) 80 MM AND BELOW


 STAINLESS STEEL PIPE TO BS 41271.

 JOINTS COMPRESSION & FITTINGS TO

 BS 864: PART 2.
- ii) 80 MM AND ABOVE

MDPE PIPE TO BS 6920 : 1988 : PART 2. JOINTS COMPRESSION & FITTINGS TO DIN 16928 : PART 1 TO 12

- 3. ALL FINAL CONNECTION TO BE 150 UNLESS OTHERWISE STATED.
- 4. PROVIDE A STOP COCK FOR WATER INLET TO EVERY PLUMBING & SANITARY FIXTURES.
- 5. ALL STOP COCKS TO BE CHROME PLATED TYPE.
- 6. ALL PIPES ARE IN MM.
- 7. WATER PIPE 65 MM AND BELOW USED FOR CONNECTION BETWEEN THE WATER MAIN TAP-OFF AND THE WATER METER SHALL BE STAINLESS STEELS PIPE TO BS4127:PART 2.

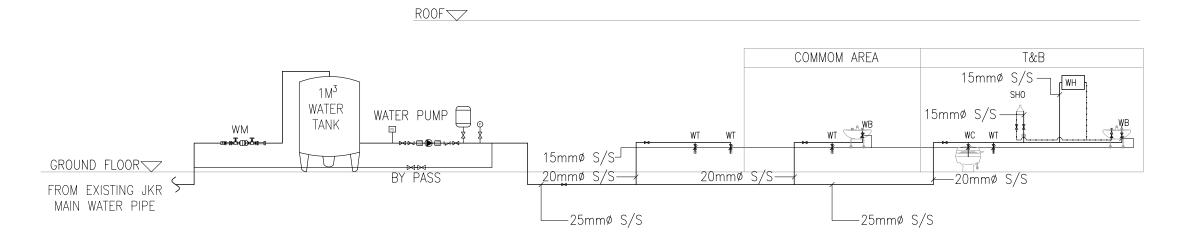

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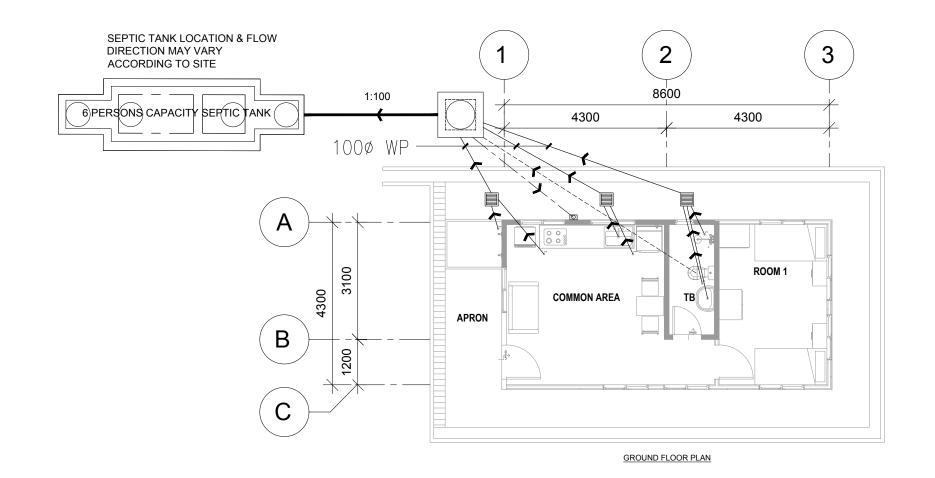


PROJECT TITLE

DRAWING TITLE PLUMBING SCHEMATIC DIAGRAM (FOR 2 PERSONS)					
DRAWN BY:	AIM	DESIGN BY:	AIM	SCALE:	NTS
CHECKED BY:	CLT	DATE:	SEPT 2022	JOB NO:	254
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PROJECT TITLE

PROPOSED NEW 1 UNIT STANDARD DESIGN OF FARM LABOUR QUARTERS, BRUNEI DARUSSALAM (FOR 2 PERSONS)

GROUND FLOOR PLAN SANITARY LAYOUT (FOR 2 PERSONS)							
DRAWN BY:	AIM	DESIGN BY:	AIM	SCALE:	1:100		
CHECKED BY:	CLT	DATE:	SEPT 2022	JOB NO:	254		

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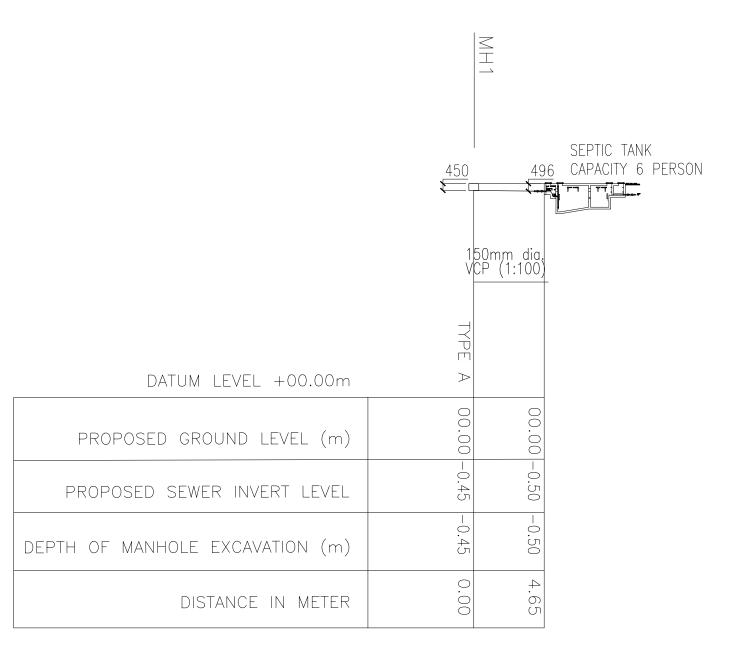


PROPOSED NEW 1 UNIT STANDARD DESIGN OF FARM LABOUR QUARTERS, BRUNEI DARUSSALAM (FOR 2 PERSONS)

PROJECT TITLE

DRAWING TITLE		SANITARY SCHEMATIC DIAGRAM (FOR 2 PERSONS)		
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DRAWING NO:	JOMC/254/SEW/300			

NOTE: CONTRACTOR TO DETERMINE THE FINAL DATUM LEVEL AT SITE.



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PROJECT TITLE

DRAWING TITLE SANITARY SEWER LINE INVERT LEVEL (FOR 2 PERSONS)					
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